

Hope Lodge®

11432 Mayfield Rd Cleveland, OH

S.O. Number: 189603


Created: 03.11.2024

Revised: 02.04.2025



Site Plan

- son Non-Illuminated Replacement Panel
- Parking Replacement Panels (6)
- so3 Parking Replacement Panel
- 804 New Parking Panel
- 805 Non-Illuminated Panel Sign
- 806 Non-Illuminated Post and Panel Sign
- so7 Removal
- 808 Non-Illuminated Post and Panel Sign
- Non-Illuminated Wall Sign
- 810 Non-Illuminated Panel Sign
- sıı Parking Replacement Panel
- S12 Non-Illuminated Panel Sign
- S13 Non-Illuminated Wall Sign
- S14 Parking Replacement Panel
- Parking Replacement Panel
- S16 Parking Replacement Panel

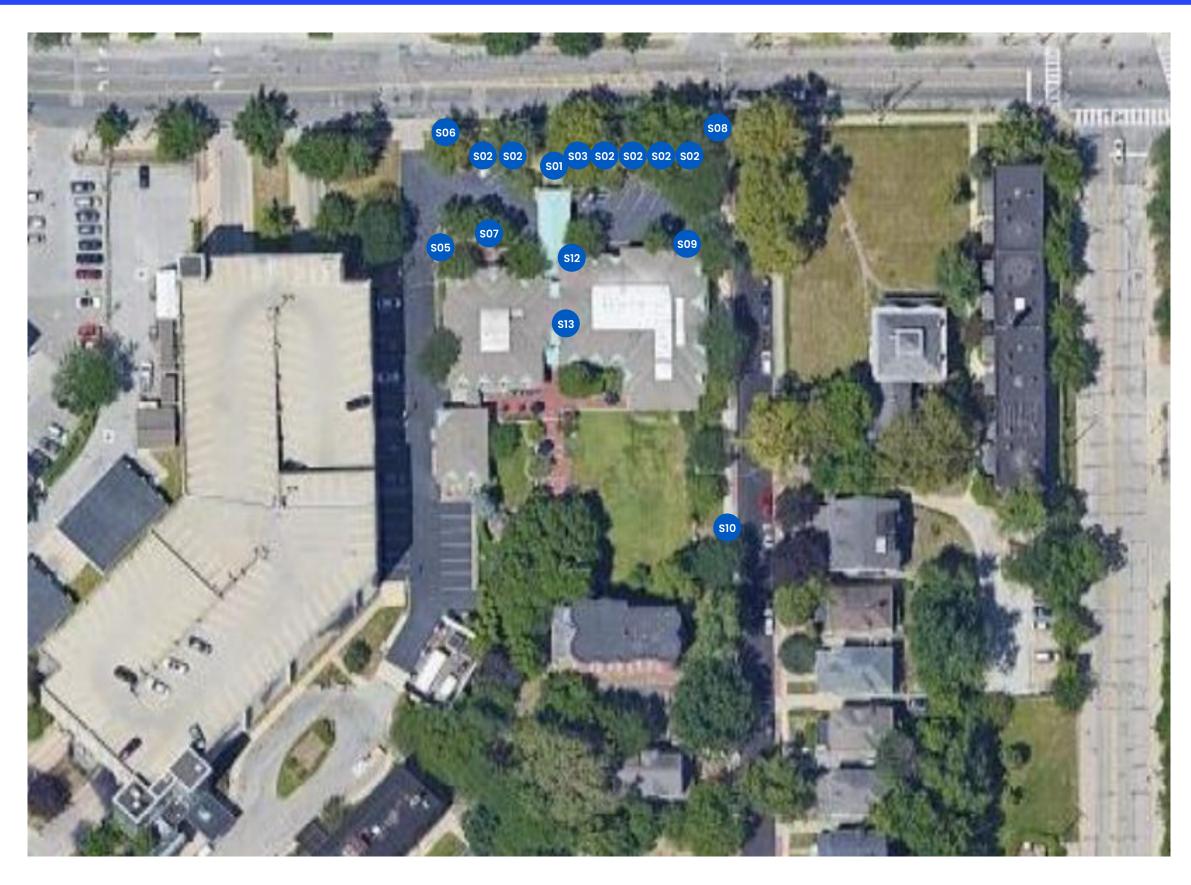



National Headquarters: 1077 West Blue Heron Blvd. West Palm Beach, Florida 33404

Action:

- Remove existing FCO letters and Window acrylic piece.
- · Install new FCO letters as shown.

Material & Color:


Painted White (Satin)



Existing



Proposed

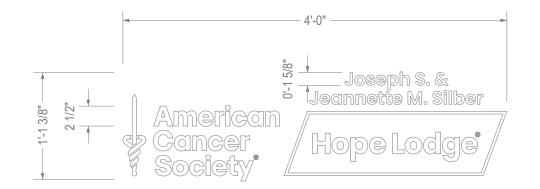

scale: 1 = 1'-0"





| National Headquarters: 1077 West Blue Heron Blvd. | 09.30.24 Various re |
|---|---------------------|
| West Palm Beach, Florida 33404 | 02.04.25 Changed S |
| 800.772.7932 | 03.10.25 Added no |
| | |
| www.atlasbtw.com | |

| Revisions: | |
|---|--|
| 09.30.24 Various revisions | |
| 02.04.25 Changed S01 and S09 to white FCO letters | |
| 03.10.25 Added note about straightening posts as needed | |
| | |
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| | |

S01

Address: 11432 Mayfield Rd PM: SP City State: Cleveland, OH Drawn By: **AF**

Date: 03/11/2024 | S.O. # 189603



Parking Replacement Panels (6)

Action:

- Remove existing panel
- Install new panel on existing post.
- · Straighten poles as needed.

Material & Color:

- 3M Vinyl 3630-37 Sapphire Blue
- M Vinyl 3630-143 Poppy Red
- Aluminum Painted White (Satin)



Existing



Proposed



National Headquarters: 1077 West Blue Heron Blvd.

West Palm Beach, Florida 33404

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scale: 1 1/2" = 1'-0"



| Revisions: | |
|---|--|
| 09.30.24 Various revisions | |
| 02.04.25 Changed S01 and S09 to white FCO letters | |
| 03.10.25 Added note about straightening posts as needed | |
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S02

PM: SP Address: 11432 Mayfield Rd
Drawn By: AF City State: Cleveland, OH

Date: 03/11/2024 | S.O. # 189603



Parking Replacement Panel

Action:

- Remove existing panel
- Install new panel on existing post.
- · Straighten poles as needed.

Material & Color:

- 3M Vinyl 3630-37 Sapphire Blue
- M Vinyl 3630-143 Poppy Red
- Aluminum Painted White (Satin)



Existing



Proposed



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scale: 1 1/2" = 1'-0"



| Revisions: | |
|---|--|
| 09.30.24 Various revisions | |
| 02.04.25 Changed S01 and S09 to white FCO letters | |
| 03.10.25 Added note about straightening posts as needed | |
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SO3

PM: SP Address: 11432 Mayfield Rd
Drawn By: AF City State: Cleveland, OH

Date: 03/11/2024 | S.O. # 189603




Action:

• Install new panel on wall behind keypad as shown.

Material & Color:


- 3M Vinyl 3630-37 Sapphire Blue
- 3M Vinyl 3630-143 Poppy Red
- Aluminum Painted White (Satin)

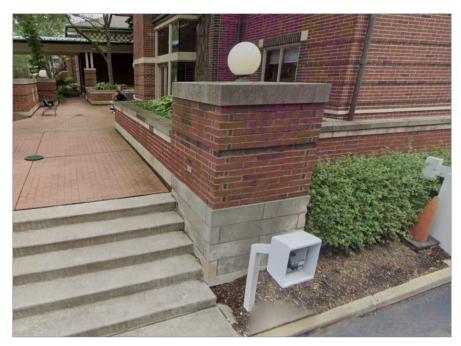

Existing



Proposed

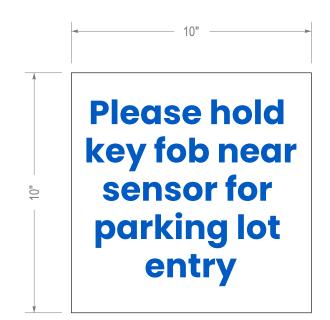



| Revisions: | |
|---|--|
| 03.08.24 Updated to replacement banner. | |
| 09.30.24 Various revisions | |
| 02.04.25 Changed S01 and S09 to white FCO letters | |
| 03.10.25 Added note about straightening posts as needed | |
| | |

PM: SP Address: 11432 Mayfield Rd City State: Cleveland, OH Drawn By: **AF**

S05

Date: 03/11/2024 | S.O. # 189603

Non-Illuminated Post and Panel Sign 📴 Parking Replacement Panel



Action:


• Install new 2" deep non-illuminated post and panel sign.

Material & Color:


Painted White

3M Vinyl 3630-37 Sapphire Blue


3M Vinyl 3630-143 Poppy Red

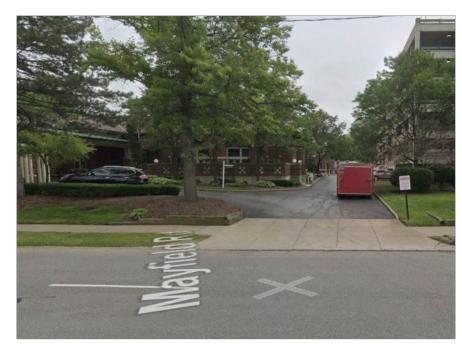

Existing

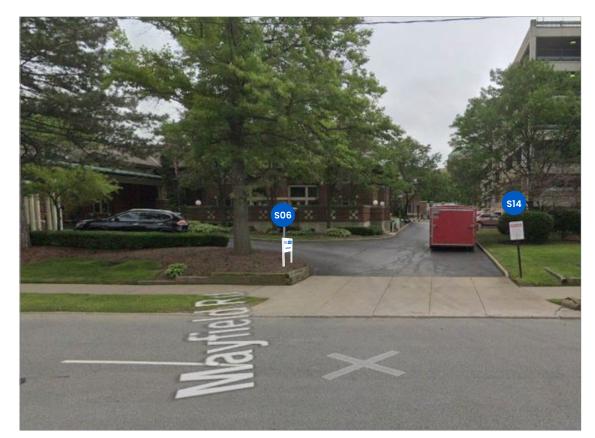

Proposed

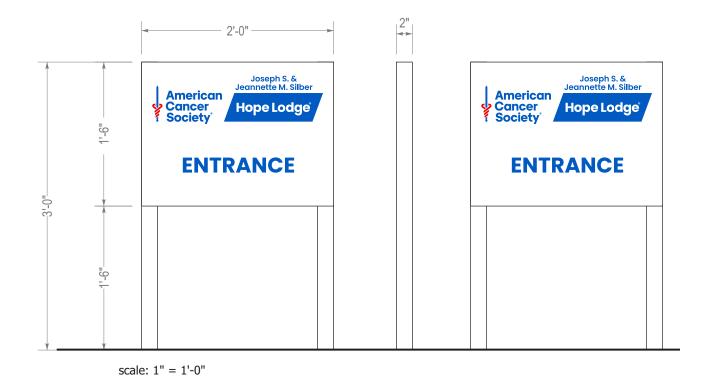



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|---|--|
| West Palm Beach, Florida 33404 | |
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| Revisions: | | |
|---|--|---|
| 09.30.24 Various revisions | | |
| 02.04.25 Changed S01 and S09 to white FCO letters | | C |
| 03.10.25 Added note about straightening posts as needed | | - |
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S06/S14

| PM: SP | Address: | 11432 Mayfield Rd |
|---------------------|-------------|-------------------|
| Drawn By: AF | City State: | Cleveland, OH |
| | | |

Date: 03/11/2024 | S.O. # 189603



Action:

• Retain as is.



Existing



| Revisions: | |
|---|--|
| 09.30.24 Various revisions | |
| 02.04.25 Changed S01 and S09 to white FCO letters | |
| 03.10.25 Added note about straightening posts as needed | |
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| PM: SP | Address: 11432 Mayfield F | ₹d |
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| Drawn By: AF | City State: Cleveland, OH | |
| Date: 03/11/2024 | s.o. # 189603 | Page# 8 |



Non-Illuminated Post and Panel Sign

Action:

• Install new 2" deep non-illuminated post and panel sign.

Material & Color:

Painted White

3M Vinyl 3630-37 Sapphire Blue


3M Vinyl 3630-143 Poppy Red



Existing



Proposed

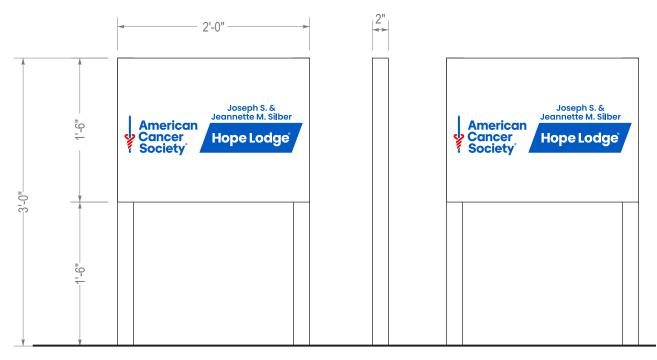

scale: 1" = 1'-0"



| Revisions: | |
|---|--|
| 09.30.24 Various revisions | |
| 02.04.25 Changed S01 and S09 to white FCO letters | |
| 03.10.25 Added note about straightening posts as needed | |
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S08

PM: SP Address: 11432 Mayfield Rd
Drawn By: AF City State: Cleveland, OH

Date: 03/11/2024 | S.O. # 189603

| SC | 9 |
|----|---|
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Action:

· Install new FCO letters as shown.

Material & Color:

Painted White (Satin)



Existing



Proposed





Address: 11432 Mayfield Rd PM: SP City State: Cleveland, OH Drawn By: **AF**

Non-Illuminated Panel Sign

Action:

• Install new flat aluminum panel on existing gate as shown.


Material & Color:

- 3M Vinyl 3630-37 Sapphire Blue
- 3M Vinyl 3630-143 Poppy Red
- Aluminum Painted White (Satin)



Existing



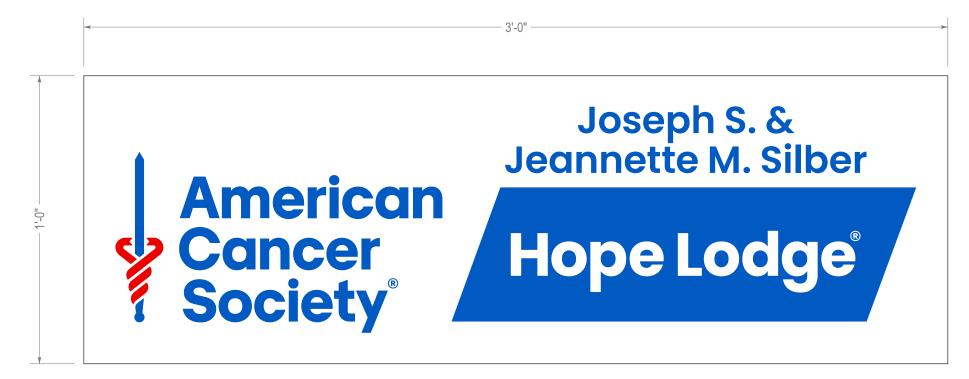

scale: 3" = 1'-0"



| Revisions: | |
|--|--|
| 9.30.24 Various revisions | |
| 2.04.25 Changed S01 and S09 to white FCO letters | |
| 3.10.25 Added note about straightening posts as needed | |
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| | PM: SP | Address: | 11432 Mayfield F | ≀d |
|------------|---------------------|-------------|------------------|----|
| S10 | Drawn By: AF | City State: | Cleveland, OH | |
| | | | | |

Date: 03/11/2024 | S.O. # 189603





Parking Replacement Panel SID Parking Replacement Panel

Action:

- Remove existing panels.
- Install new flat aluminum panel as shown.

Material & Color:

- 3M Vinyl 3630-37 Sapphire Blue
- 3M Vinyl 3630-143 Poppy Red
- Aluminum Painted White (Satin)



Existing



Proposed



scale: 1 1/2" = 1'-0"



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| www.atiasbtw.com | |

| Revisions: | |
|---|--|
| 09.30.24 Various revisions | |
| 02.04.25 Changed S01 and S09 to white FCO letters | |
| 03.10.25 Added note about straightening posts as needed | |
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S11/S15

| PM: SP | Address: | 11432 Mayfield Rd |
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| Drawn By: AF | City State: | Cleveland, OH |
| | | |

Date: 03/11/2024 | S.O. # 189603


Non-Illuminated Panel Sign

Action:

• Install new flat aluminum panel as shown.

Material & Color:


- 3M Vinyl 3630-37 Sapphire Blue
- 3M Vinyl 3630-143 Poppy Red
- Aluminum Painted White (Satin)

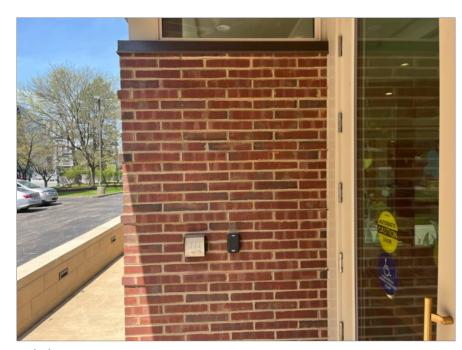

Existing



Proposed

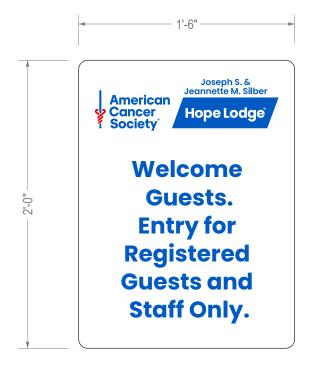

scale: 1 1/2" = 1'-0"



| Revisions: | |
|---|--|
| 09.30.24 Various revisions | |
| 02.04.25 Changed S01 and S09 to white FCO letters | |
| 03.10.25 Added note about straightening posts as needed | |
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| PM: SP | Address: 11432 Mayfield F | ≀d |
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| Drawn By: AF | City State: Cleveland, OH | |
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S12

Date: 03/11/2024 | S.O. # 189603


Non-Illuminated Wall Sign

Action:


• Install new brake formed aluminum panel as shown.

Material & Color:

- 3M Vinyl 3630-37 Sapphire Blue
- 3M Vinyl 3630-143 Poppy Red
- Aluminum Painted White (Satin)

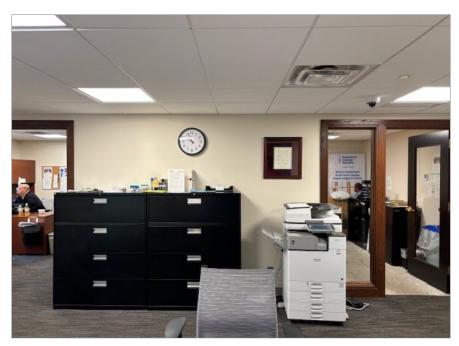

Existing

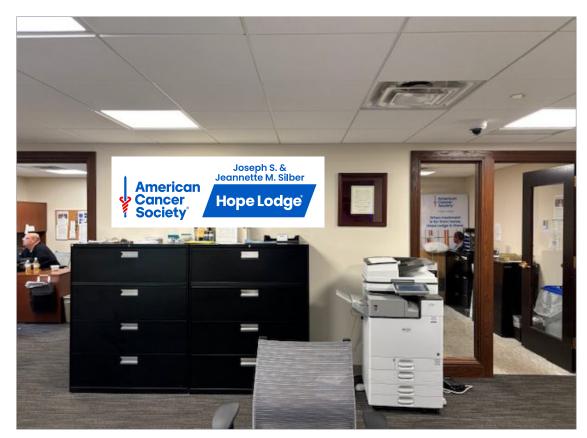

Proposed



scale: 1 1/2" = 1'-0"



| Revisions: | |
|---|--|
| 09.30.24 Various revisions | |
| 02.04.25 Changed S01 and S09 to white FCO letters | |
| 03.10.25 Added note about straightening posts as needed | |
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| PM: SP | Address: 11432 Mayfield Rd |
|---------------------|----------------------------|
| Drawn By: AF | City State: Cleveland, OH |
| | |

Date: 03/11/2024 | S.O. # 189603

S13



| Ac | tin | n: |
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| $\neg c$ | CIO | н. |

- Remove existing panel on rear gate.
- Install new flat aluminum panel on rear gate.

Material & Color:

- 3M Vinyl 3630-143 Poppy Red
- Aluminum Painted White (Satin)

Existing

scale: 1 1/2" = 1'-0"

800.772.7932 www.atlasbtw.com

West Palm Beach, Florida 33404

National Headquarters: 1077 West Blue Heron Blvd.

Lot No. 74 Hope Lodge PRIVATE PARKING Vehicles not authorized to park on this property and those parking in violation of the rules and regulations will be towed. Vehicles taken to and recovered from; UNIVERSITY CIRCLE, **INCORPORATED** 12100 EUCLID AVENUE **CLEVELAND, OH 44106** 791-6226 Tow Charge \$70.00 **Storage \$8.00 - 24 Hours**

| Revisions: | | |
|---|--|--|
| 09.30.24 Various revisions | | |
| 02.04.25 Changed S01 and S09 to white FCO letters | | |
| 03.10.25 Added note about straightening posts as needed | | |
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Proposed

| PM: SP | Address: 11432 Mayfield F | Rd | | |
|---------------------|---------------------------|----|--|--|
| Drawn By: AF | City State: Cleveland, OH | | | |
| Date: 03/11/2024 | S.O. # 189603 Page# 15 | | | |

S16

9014 CEDAR AVENUE EXISTING BUILDING DEMOLITION

April 24, 2024

Cedar Health Realty, LLC





The Gardens of Fairfax Healthcare Center Project Data

- Cedar Health Realty, LLC purchased the property this year (2024) with two primary structures (Formerly Fairfax Place Retirement Home).
- Cedar Health Realty, LLC is associated with Foundations Health Solutions, a leading Ohio long-term care provider, managing nearly 60 nursing homes specializing in physical therapy and skilled nursing.
- Ocedar Health Realty, LLC purchased the subject property located at 9014 Cedar Avenue in 2024. The property consists of two primary structures that together served as Fairfax Place Retirement Home for 98 residents. The original structure was constructed in 1891 with a later addition at the rear. The second structure was constructed in 1995.
- Cedar Health Realty, LLC is currently engaged in renovating the 1995 structure to meet current standards for a nursing home and to update all interior finishes.

Cedar Health Realty, LLC is proposing the construction of a new addition to the 1995 structure that will provide 39 additional private rooms for the care of ventilator patients. The additional rooms provided in the addition will also serve to eliminate all but 6 of the current semi-private rooms and convert them to private occupancy.




The Gardens of Fairfax Healthcare Center Project Data

- Requesting CPC approval to demolish the 1891 structure (9014 Cedar Ave)
- Earlier this year Cedar Health Realty, LLC had hazardous material abatement completed, as well as cleaned out building including removal of furniture, medical equipment and rubbish.
- Electricity, natural gas and telecommunications utility disconnects have been completed to the building, and First Energy has approved utility pole removals from site immediately adjacent to the structure.
- Scope of work would include removal of existing structure and backfill of basement void to leave site in a useable state ready for future project.




Aerial Site Map - Existing Vicinity

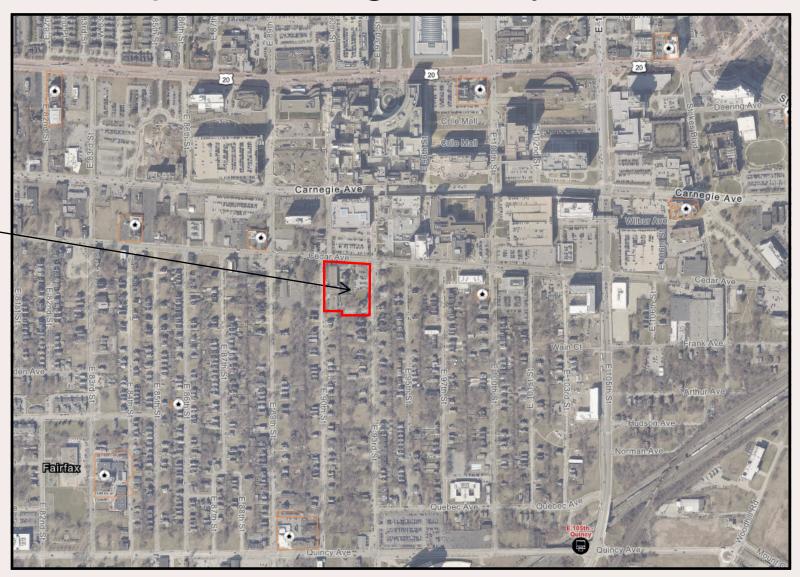

9014 CEDAR AVE

Aerial Site Map - Existing Conditions

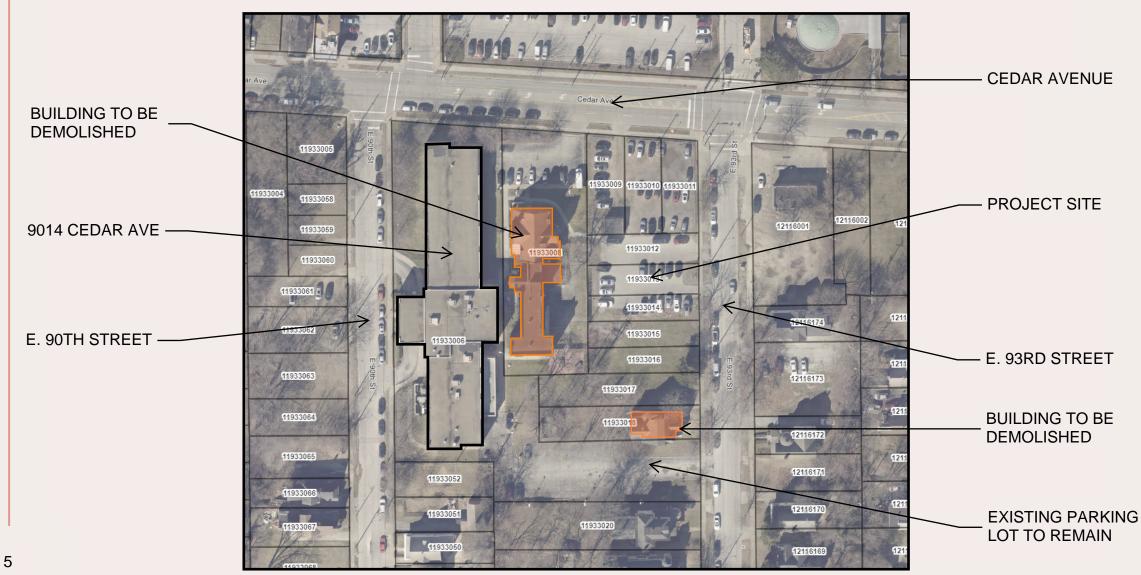

341.08 - a-1 Building History

- (a) Criteria for Action. In considering a request to demolish or move a building or other structure located within a Design Review District, the City Planning Commission and its Local Design Review Advisory Committee shall consider the following factors in making its decision to approve or disapprove the request:
 - (1) The architectural and historic significance of the subject building or structure
 - a. The building is designed by Charles Schweinfurth.

 https://shakerlibrary.org/wp-content/uploads/Cleveland-Landmarks-Commission-Cleveland-City-Planning-....pdf
 - b. It originated as Infants Rest Inner City Nursing Home in 1891 (home for children under 2 years)
 - c. Holy Cross House (for children) purchased the property in 1915, a transitional location in their organization's history https://case.edu/ech/articles/h/holy-cross-house
 - d. Mount Zion Church purchased the property in the 1930's, a transitional location in their organization's history. Mount Zion Church renovated the property and added on to it, modifications including a sanctuary, gym, offices, and basement dining. https://www.mtzioncleveland.com/an-historic-church
 - e. New Sardis Church purchased the property in the 1950, a transitional location in their organization's history. New Sardis vacated the property in 1959. https://www.newsardispbc.org/our-story
 - f. In 1996, the property transferred to Senior Care Resources.

341.08 - a-2-3 Building Significance

- (2) The significance of the building or structure in contributing to the architectural or historic character of its environs
 - a. The most significant period of the property's history is it's founding, when it opened as a home to care for orphaned infants.
 - b. Since that opening, the building has been purchased and utilized as a church, children's home, and nursing home. Each transaction represented a piece of each organization's history as no organization was founded in the building after it's purchase, nor was it the last location for any organization as each went on to move elsewhere in the region.
- (3) In the case of a request to move a building or other structure, the relationship between the location of the subject building or structure and its overall significance
 - a. This section does not apply as the design team is proposing a total demolition of the structure

341.08 - a-4 Viability and Existing Conditions


- (4) The present and potential economic viability of the subject building or structure, given its physical condition and marketability
 - a. The structure creates several challenges and hazards if salvaged, which are not only non-marketable, but also against modern building codes and life threatening to the proposed occupancy of elderly patients and patients with compromised respiratory and immune systems.
 - o Building Condition The original structure has remained unoccupied for an extended period of time serving only as overflow storage space. It has long been neglected with little to no maintenance and there currently are no utilities servicing the building. Over years of neglect the building has incurred significant water intrusion through the exterior masonry walls and roof that has resulted in the deterioration of all interior construction and structural elements.
 - o Air Quality A mold study was conducted in February of 2025 (See Attached). The 1891 building is not suitable to be used in conjunction with a nursing home environment that is specifically being developed to accommodate ventilator patients with compromised respiratory systems. The presence of any mold spores would create an unacceptable health care risk and liability to the treatment of those patients or any elderly population with compromised immune systems. The design team highly recommends demolition of the existing structure to mitigate this issue.
 - o Accessibility The existing construction of the 1891 building creates a significant hardship with regards to the health safety and welfare of the occupants to its conversion for any future use to meet current Ohio Building Code, NFPA Life Safety Code and ADA standards. The 1995 structure and 1891 structure have differing finished floor elevations of at least 2'-0". Connecting both would require a series of ramps and other modifications. Health care codes require 8'-0" wide corridors for the movement of patient beds. A series of ramps would be detrimental to patient movement and egress as most patients are confined to a wheelchair or bed. Dining, physical therapy, dialysis, and activity spaces are located in the existing 1995 structure. It would require a minimum of 3 trips daily when only accounting for access to meals.
 - o Fire Protection The existing construction of the 1891 building as a two-story wood frame structure is not permitted for an Institutional (I2) nursing home occupancy.
 - o Building Location The proposed addition will be required to meet all the Euclid Corridor Design District zoning and design standards. Those standards require exterior pedestrian green space along Cedar Avenue and all parking to be located to the "rear" of the building. The size and location of the 1891 structure on the site will prevent being able to meet those conditions and will also not permit the development of adequate on-site parking.

341.08 - a-5-6-7 Existing Conditions and Use

- (5) The presence of conditions on the subject property that are dangerous or are detrimental to the immediate area and cannot be reasonably remedied other than by the proposed demolition
 - a. These concerns have been addressed in Item a-4
- (6) The degree to which the applicant proposes to salvage and facilitate re-use of structures proposed for demolition
 - a. Based on the environmental hazards present in the existing building, the design team proposes full demolition of the structure without salvage
- (7) The design quality and significance and the appropriateness of the proposed re-use of the property
 - a. The property will continue to operate as a nursing home. The proposed demolition will permit the construction of a proposed addition which will improve and expand the standard of care and services that the facility provides for the inner-city residents that it currently serves. It will prevent those residents and their families from having to travel outside of their neighborhood to seek quality and specialized care. The existing facility is primarily semi-private rooms. The proposed addition will provide 43 private rooms which will permit the conversion of 39 semi-private rooms into private occupancy for a total of 82 private rooms. The private rooms will provide a more comfortable and dignified living environment, a personal space for residents to visit with their families and protect patients' privacy rights.
 - b. The existing 1891 building and more recently constructed 1995 building have no contextual similarities to each other. One represents a more traditional residential character while the other a more modern institutional character. The proposed addition and the renovation of the existing exterior facade of the 1995 will create an overall more harmonious modern character for the entire facility. The building will be more reflective of the existing Cleveland Clinic development that is immediately opposite the Gardens of Fairfax along the north side of Cedar Avenue.

ARCHWAY TO BE SALVAGED AND INSTALLED IN GREEN SPACE



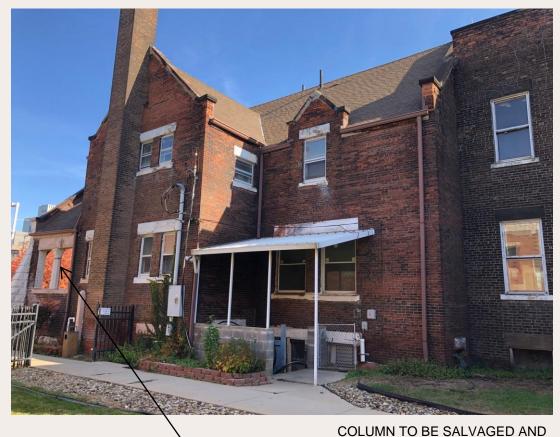


INSTALLED IN GREEN SPACE

CEDAR AVENUE FAÇADE - NORTH


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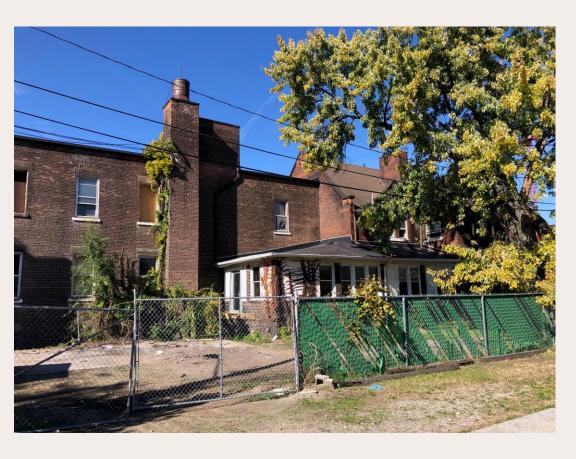
WEST FAÇADE FROM SOUTH




REAR FAÇADE - SOUTH

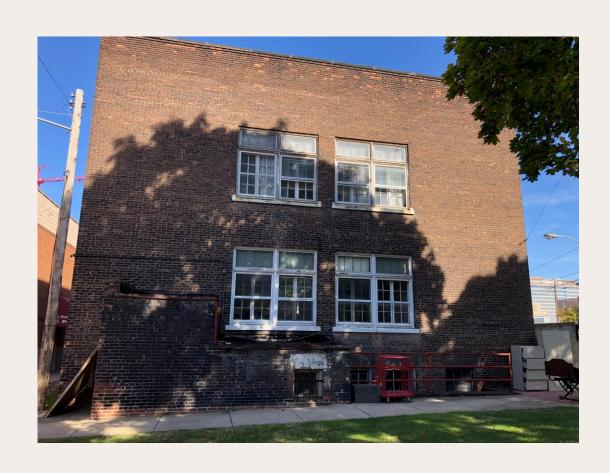

EAST FAÇADE - SOUTH

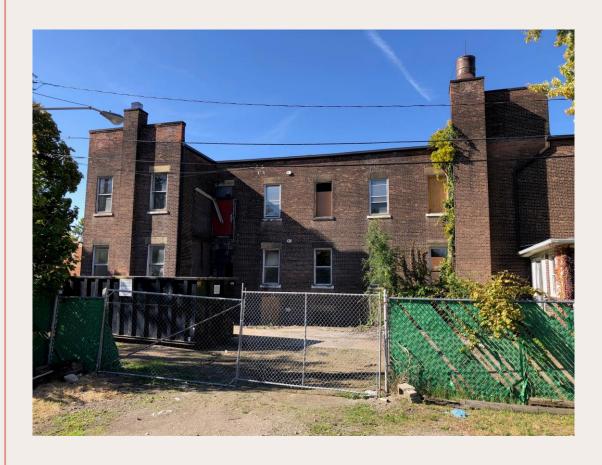

EAST FAÇADE - NORTH

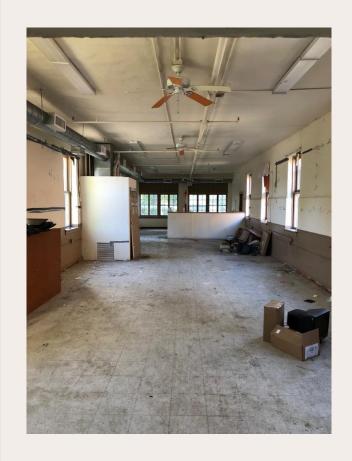







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INTERIOR

INTERIOR



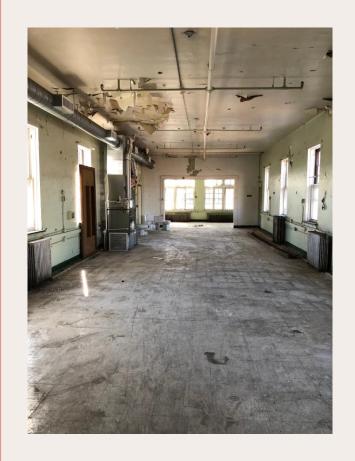

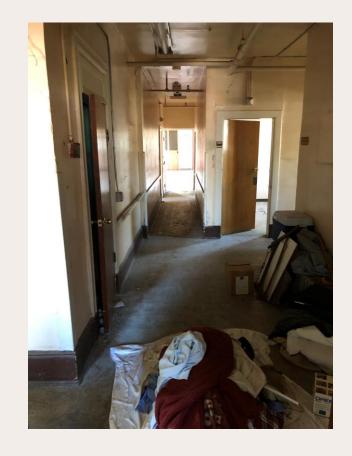

INTERIOR


INTERIOR

INTERIOR

Project Schedule

| | ARDEN: T TIMELIN ,2025 | | | | | | | | | | | | | | | | |
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| TASKS | | | | | | ı | ı | 20 | | | | | | 2026 | | | |
| D-14 | | 1 | 1 | | 1 | 1 | APRIL | MAY | JUNE | JULY | AUGUST | SEPTEMBER | OCTOBER | NOVEMBER | MARCH | THRU | DECEMBER |
| ITE DEMO | PETBOT Me | -4: | | | | | 4/15/2025 | | | | | | | | | | |
| | PEIDUIME | eung | | | | | 4/15/2025 | | | | | | | | | | |
| | Demolition | Permit App | roval | | | | | | | | | | | | | | |
| | | Demolition | | lication | | | 4/17/2025 | | | | | | | | | | |
| | | | iew Commi | | g | | 4/24/2025 | | | | | | | | | | |
| | | | ommission | | | | 4/25/2025 | | | | | | | | | | |
| | | 0 1 | | | | | | | | | | | | | | | |
| | 1891 Buildi | ing Demoliti | on | | | | | 5/5/2025 | 6/13/2025 | | | | | | | | |
| | | | | | | | | | | | | | | | | | |
| | House Den | nolition | | | | | | | 6/16/2025 | 6/27/2025 | | | | | | | |
| | | | | | | | | | | | | | | | | | |
| ESIGN R | EVIEW & API | | | | | | | | | | | | | | | | |
| | Conceptua | | | | | | | | | | | | | | | | |
| | | Design Rev | | | | | | 5/1/2025 | | | | | | | | | |
| | | Design Rev | | | al | | | 5/8/2025 | | | | | | | | | |
| | | Planning Co | ommission | Approval | | | | 5/9/2025 | | | | | | | | | |
| | | | | | | | | | | | | | | | | | |
| | Schematic | | | | | | | | | | | | | | | | |
| | | Design Rev | | | | | | | 6/5/2025 | | | | | | | | |
| | | | iew Commi | | al | | | | 6/12/2025 | | | | | | | | |
| | | Planning Co | ommission | Approval | | | | | 6/13/2025 | | | | | | | | |
| | | | | | | | | | | | | | | | | | |
| | Final Appro | | | | | | | | | 7/40/0005 | | | | | | | |
| | | Design Rev | | | <u> </u> | | | | | 7/10/2025 | | | | | | | |
| | | | iew Commi | | al | | | | | 7/17/2025 | | | | | | | |
| | | Planning Ci | ommission . | Approvai | | | | | | 7/18/2025 | | | | | | | |
| ITE DI ANI | APPROVAL | | | | | | | | | | | | | | | | |
| IIE PLAN | Survey, Dra | wings and I | odale | | | | 4/21/2025 | 5/23/2025 | | | | | | | | | |
| | | idation Appr | | | | | 4/21/2025 | 5/26/2025 | 6/20/2025 | | | | | | | | |
| | | ering Docu | | | | | | 5/26/2023 | 6/27/2025 | | | | | | | | |
| | | Engineering. | | | | | | 0/20/2020 | 6/30/2025 | | | 9/15/2025 | | | | | |
| | | g30ig | ,,,,,,,,,,, | | | | | | | | | | | | | | |
| ONING P | ERMIT APPR | OVAL | | | | | | | | | | 9/15/2025 | 10/1/2025 | | | | |
| | 1 | | | | | | | | | | | | | | | | |
| UILDING | DEPARTME | NT APPROVA | AL | | | | | | | | | | | | | | |
| | | on Documer | | n | | | | 5/5/2025 | | | | 9/15/2025 | | | | | |
| | | de Complia | | | | | | | | | | 9/15/2025 | 10/15/2025 | | | | |
| | | | | | | | | | | | | | | | | | |
| IDDING 8 | & NEGOTIATI | ONS | | | | | | | | | | 9/15/2025 | 10/15/2025 | | | | |
| | | | | | | | | | | | | | | | | | |
| ONTRAC | T AWARD | | | | | | | | | | | | | 11/3/2025 | | | |
| | | | | | | | | | | | | | | | | | |
| ONSTRU | CTION | | | | | | | | | | | | | | 3/2/2026 | thru | 12/7/2026 |



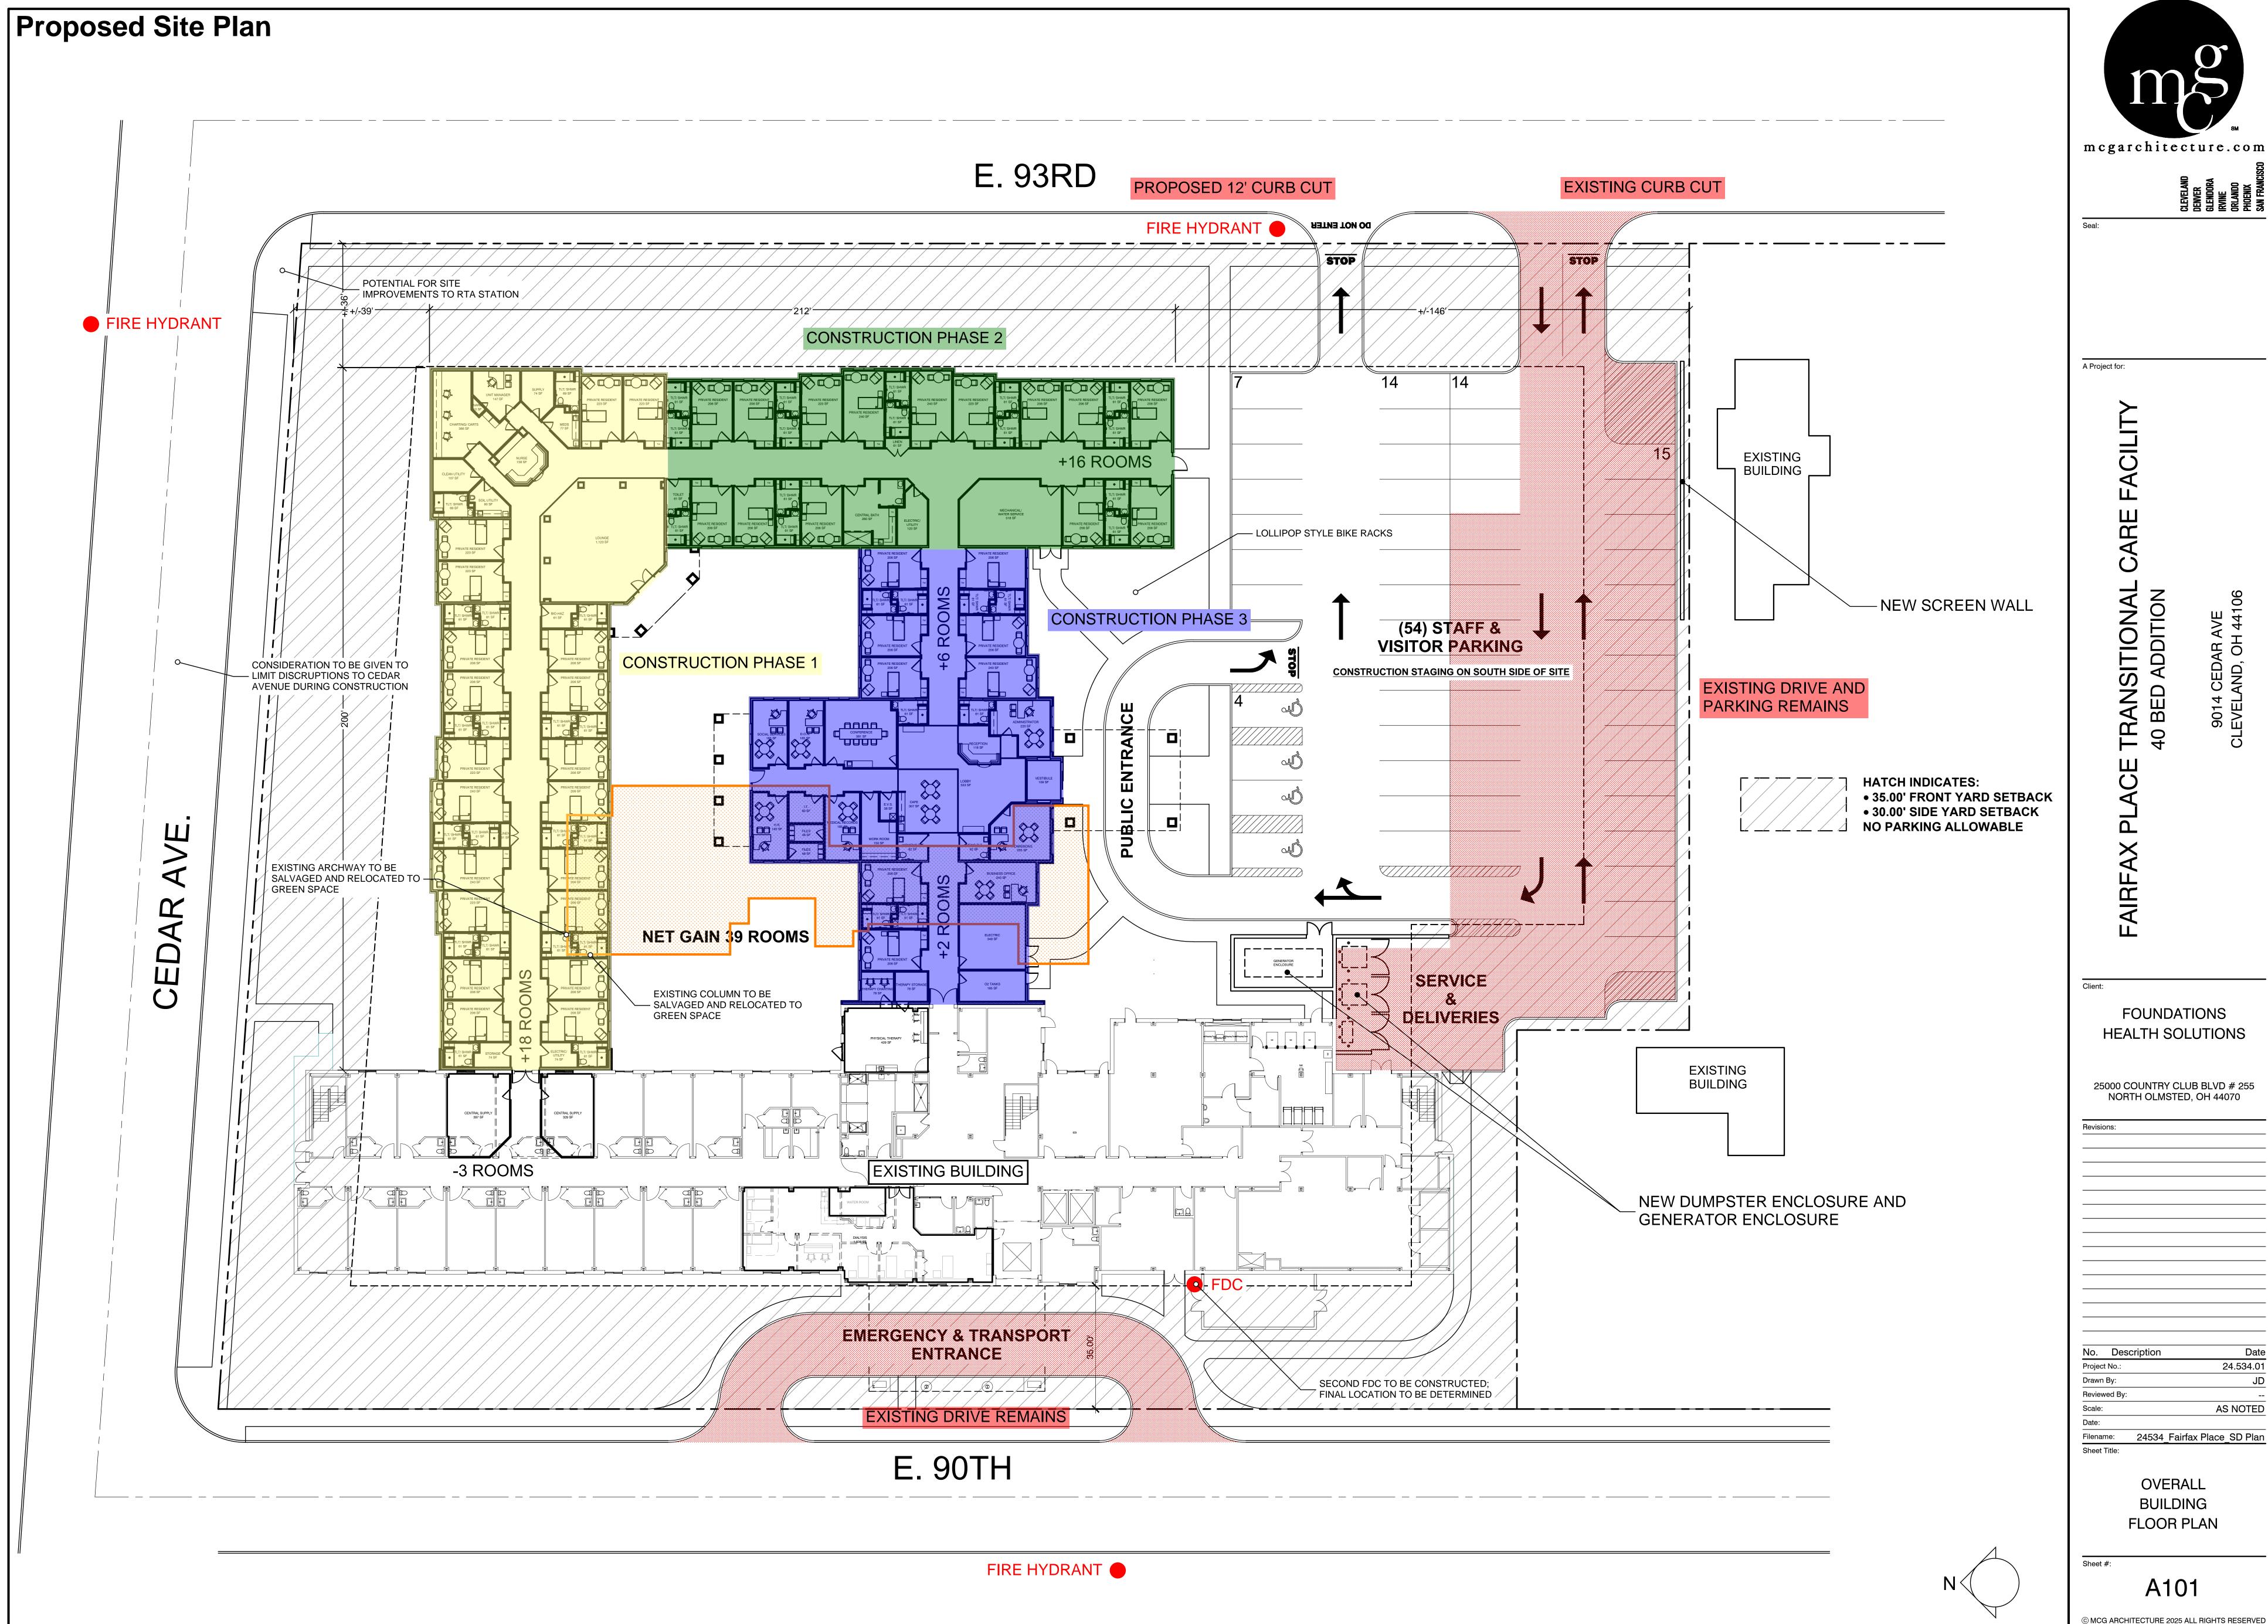



TRANSITIONAL 40 BED ADDITION

FOUNDATIONS


25000 COUNTRY CLUB BLVD # 255 NORTH OLMSTED, OH 44070

Date 24.534.01 No. Description

AS NOTED Filename: 24534 Fairfax Place SD Plan

> **OVERALL** BUILDING FLOOR PLAN

A101

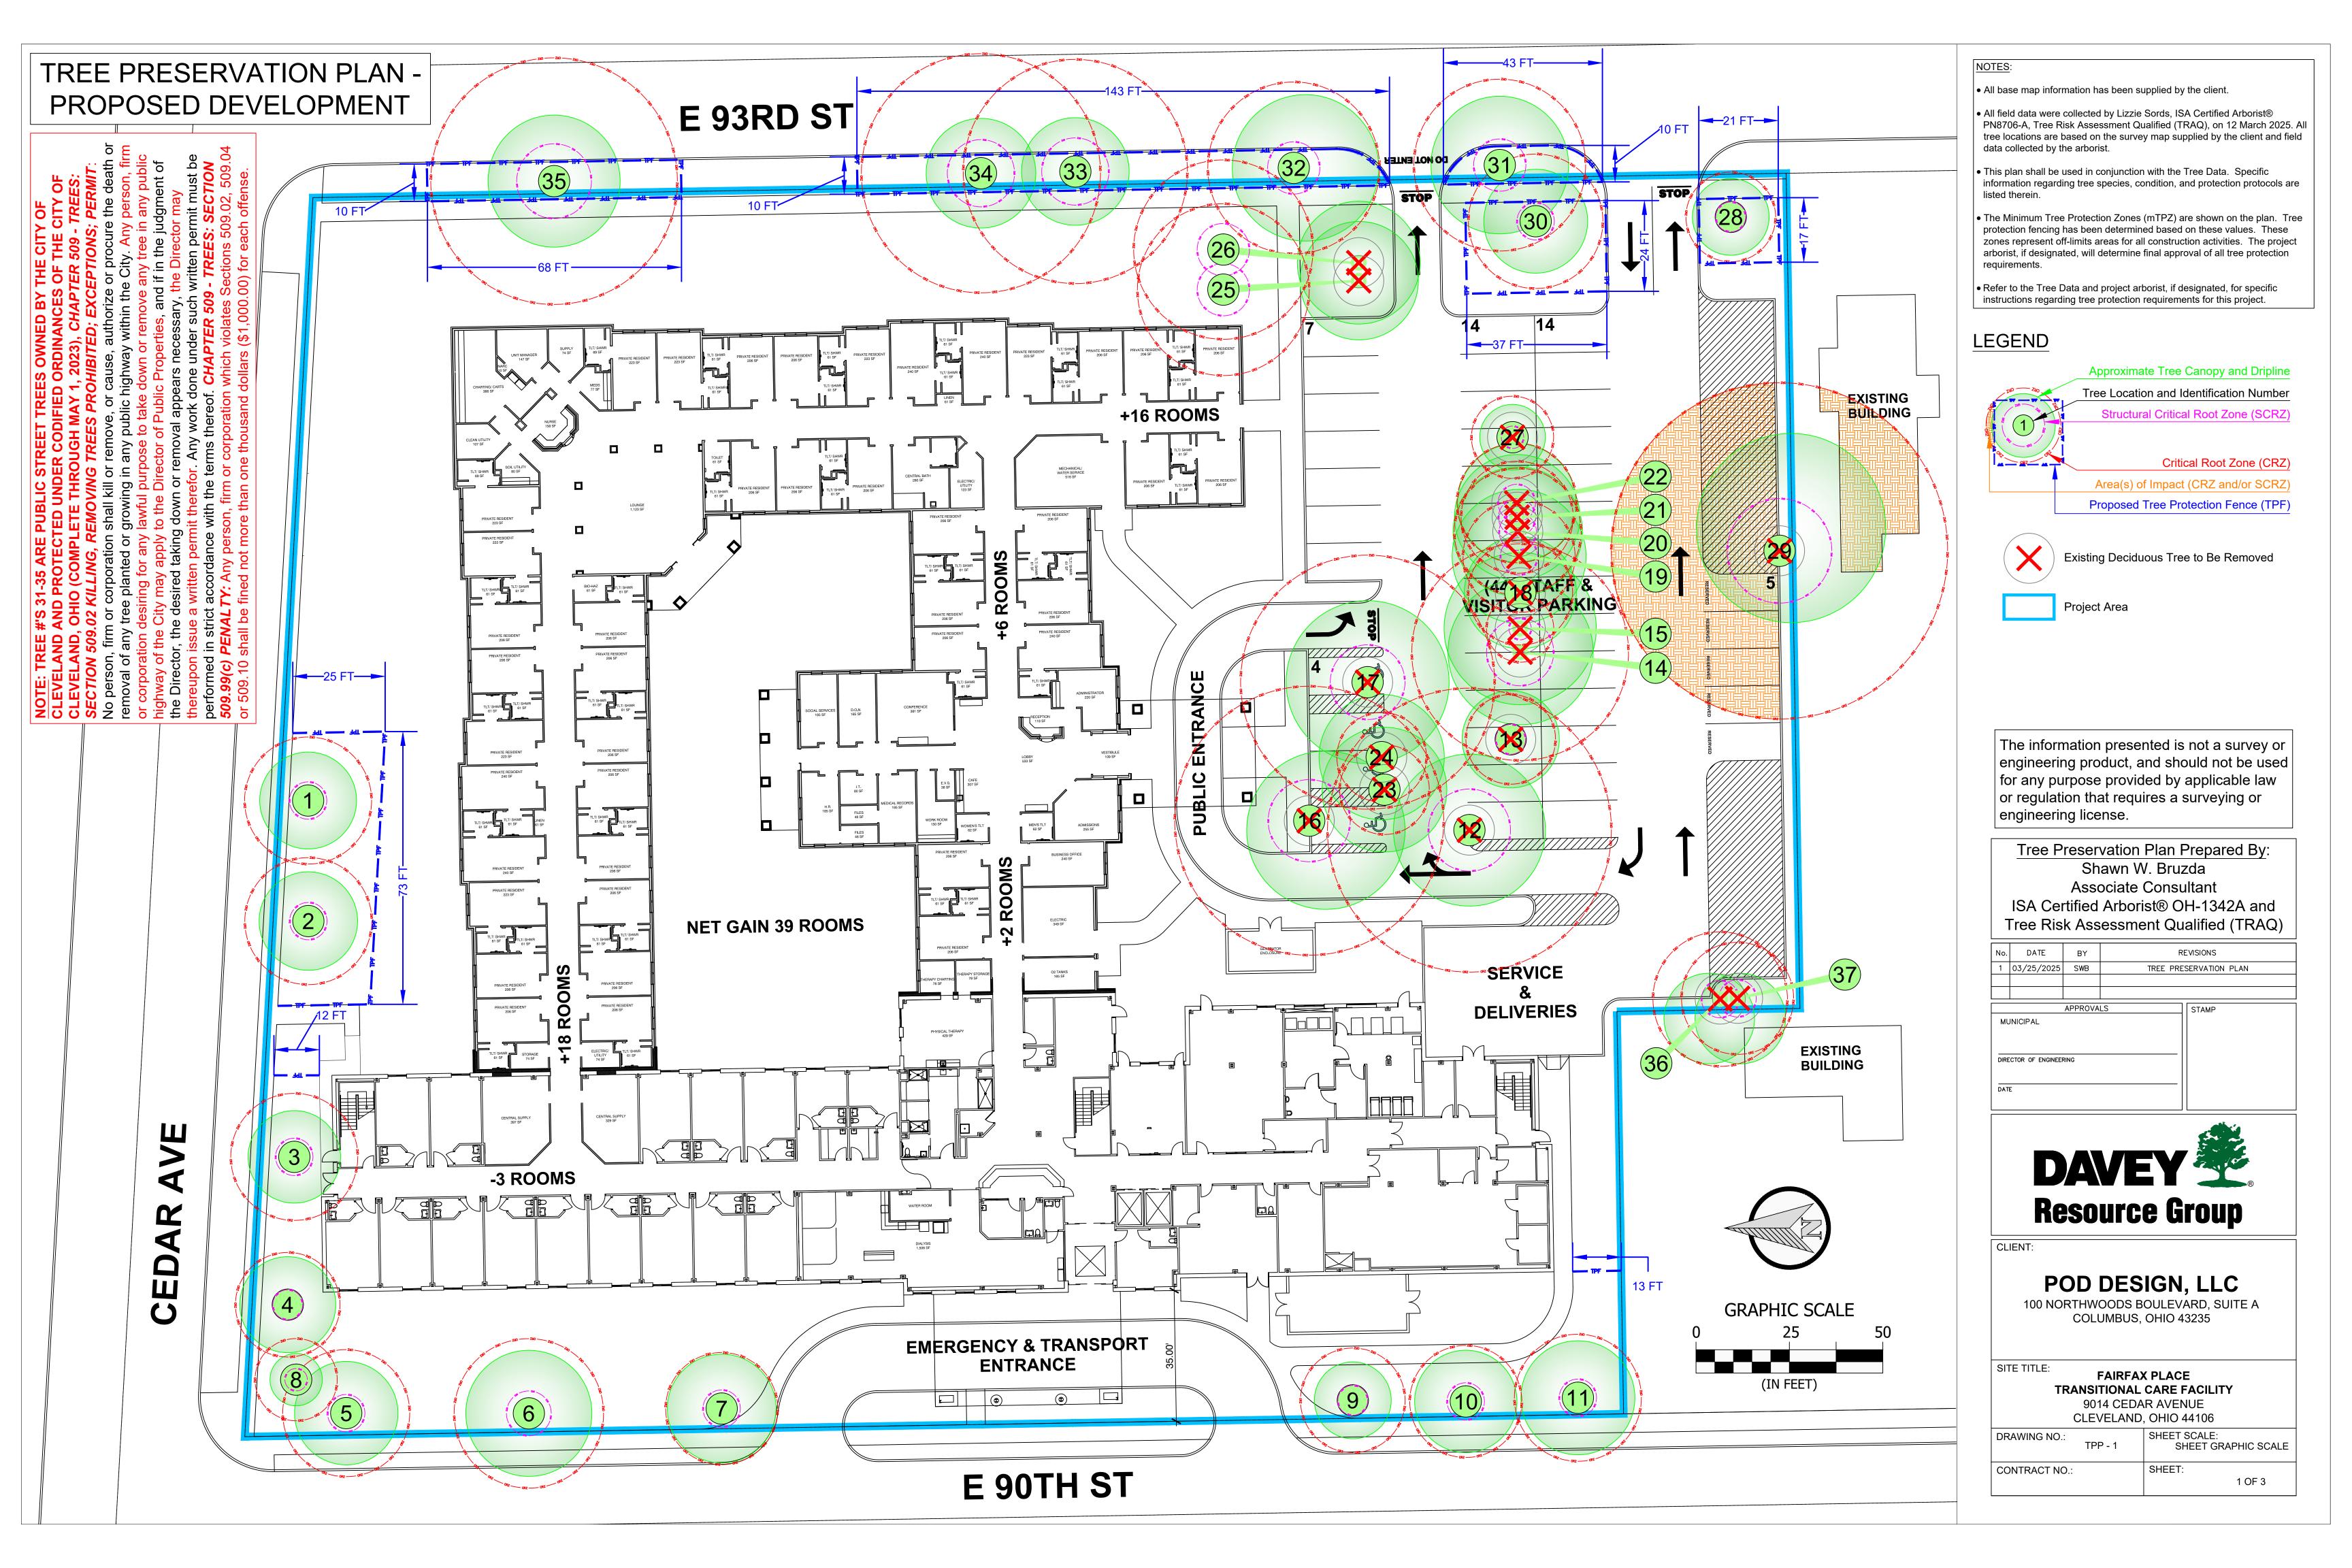

| TREE NUMBER | COMMON NAME | BOTANICAL NAME | DBH (inches) | HEIGHT (feet) | CONDITION | MAINTENANCE | STEMS | SCRZ RADIUS (feet) | CRZ RADIUS (feet) | NATIVE SPECIES? | OWNERSHIP | NOTES | DATE |
|----------------|---------------------|---------------------|-----------------|------------------|-----------|-------------|-------|-----------------------|----------------------|--------------------|-----------|--------------------|-----------|
| 1 | red maple | Acer rubrum | 11 | 25 | Fair | Prune | 1 | 5 | 17 | Yes | Private | | 12-Mar-25 |
| 2 | red maple | Acer rubrum | 11 | 25 | Fair | Prune | 1 | 5 | 17 | Yes | Private | | 12-Mar-25 |
| 3 | red maple | Acer rubrum | 11 | 25 | Fair | Prune | 1 | 5 | 17 | Yes | Private | SLF oothecae | 12-Mar-25 |
| 4 | red maple | Acer rubrum | 9 | 20 | Fair | Prune | 1 | 4 | 14 | Yes | Private | | 12-Mar-25 |
| 5 | red maple | Acer rubrum | 11 | 25 | Fair | Prune | 1 | 5 | 17 | Yes | Private | | 12-Mar-25 |
| 6 | red maple | Acer rubrum | 13 | 30 | Fair | Prune | 1 | 6 | 20 | Yes | Private | | 12-Mar-25 |
| 7 | red maple | Acer rubrum | 10 | 25 | Fair | Prune | 1 | 5 | 15 | Yes | Private | | 12-Mar-25 |
| 8 | flowering crabapple | Malus sp. | 7 | 8 | Fair | Prune | 1 | 3 | 11 | Yes | Private | | 12-Mar-25 |
| 9 | red maple | Acer rubrum | 9 | 20 | Fair | Prune | 1 | 4 | 14 | Yes | Private | | 12-Mar-25 |
| 10 | red maple | Acer rubrum | 10 | 25 | Fair | Prune | 1 | 5 | 15 | Yes | Private | | 12-Mar-25 |
| 11 | red maple | Acer rubrum | 11 | 25 | Fair | Prune | 1 | 5 | 17 | Yes | Private | | 12-Mar-25 |
| 12 | Norway maple | Acer platanoides | 25 | 50 | Poor | Remove | 1 | 11 | 38 | No | Private | severe decline | 12-Mar-25 |
| 13 | American elm | Ulmus americana | 8 | 15 | Poor | Remove | 1 | 4 | 12 | Yes | Private | | 12-Mar-25 |
| 14 | silver maple | Acer saccharinum | 19 | 35 | Fair | Remove | 1 | 9 | 29 | Yes | Private | | 12-Mar-25 |
| 15 | northern catalpa | Catalpa speciosa | 6 | 15 | Fair | Remove | 1 | 3 | 9 | Yes | Private | | 12-Mar-25 |
| 16 | Norway maple | Acer platanoides | 24 | 50 | Fair | Remove | 1 | 11 | 36 | No | Private | | 12-Mar-25 |
| 17 | Norway maple | Acer platanoides | 14,18 | 20 | Fair | Remove | 2 | 10 | 34 | No | Private | | 12-Mar-25 |
| 18 | tree of heaven | Ailanthus altissima | 9 | 15 | Fair | Remove | 1 | 4 | 14 | No | Private | | 12-Mar-25 |
| 19 | tree of heaven | Ailanthus altissima | 10 | 15 | Fair | Remove | 1 | 5 | 15 | No | Private | | 12-Mar-25 |
| 20 | American elm | Ulmus americana | 11 | 15 | Poor | Remove | 1 | 5 | 17 | Yes | Private | | 12-Mar-25 |
| 21 | American elm | Ulmus americana | 10 | 15 | Poor | Remove | 1 | 5 | 15 | Yes | Private | | 12-Mar-25 |
| 22 | Norway maple | Acer platanoides | 7,8 | 20 | Poor | Remove | 2 | 5 | 16 | No | Private | | 12-Mar-25 |
| 23 | Norway maple | Acer platanoides | 8 | 15 | Fair | Remove | 1 | 4 | 12 | No | Private | | 12-Mar-25 |
| 24 | Norway maple | Acer platanoides | 5,6 | 10 | Fair | Remove | 1 | 4 | 12 | No | Private | | 12-Mar-25 |
| 25 | tree of heaven | Ailanthus altissima | 10,12 | 15 | Fair | Remove | 2 | 7 | 23 | No | Private | | 12-Mar-25 |
| 26 | tree of heaven | Ailanthus altissima | 16 | 10 | Fair | Remove | 1 | 7 | 24 | No | Private | | 12-Mar-25 |
| 27 | tree of heaven | Ailanthus altissima | 7 | 10 | Fair | Remove | 1 | 3 | 11 | No | Private | | 12-Mar-25 |
| 28 | red maple | Acer rubrum | 8 | 20 | Fair | Prune | 1 | 4 | 12 | Yes | Private | | 12-Mar-25 |
| 29 | pin oak | Quercus palustris | 30 | 70 | Fair | Remove | 1 | 14 | 45 | Yes | Private | | 12-Mar-25 |
| 30 | red maple | Acer rubrum | 12 | 25 | Fair | Prune | 1 | 5 | 18 | Yes | Private | | 12-Mar-25 |
| 31 | sugar maple | Acer saccharum | 15 | 35 | Good | Prune | 1 | 7 | 23 | Yes | Municipal | public street tree | 12-Mar-25 |
| 32 | sugar maple | Acer saccharum | 15 | 35 | Fair | Prune | 1 | 7 | 23 | Yes | Municipal | public street tree | 12-Mar-25 |
| 33 | American basswood | Tilia americana | 20 | 40 | Fair | Prune | 1 | 9 | 30 | Yes | Municipal | public street tree | 12-Mar-25 |
| 34 | American basswood | Tilia americana | 21 | 40 | Fair | Prune | 1 | 9 | 32 | Yes | Municipal | public street tree | 12-Mar-25 |
| 35 | American basswood | Tilia americana | 22 | 40 | Poor | Prune | 1 | 10 | 33 | Yes | Municipal | public street tree | 12-Mar-25 |
| 36 | Norway maple | Acer platanoides | 12 | 20 | Poor | Remove | 1 | 5 | 18 | No | Private | | 12-Mar-25 |
| 37 | Norway maple | Acer platanoides | 10 | 15 | Poor | Remove | 1 | 5 | 15 | No | Private | | 12-Mar-25 |

NOTES

- All base map information has been supplied by the client.
- All field data were collected by Lizzie Sords, ISA Certified Arborist®
 PN8706-A, Tree Risk Assessment Qualified (TRAQ), on 12 March 2025. All tree locations are based on the survey map supplied by the client and field data collected by the arborist.
- This plan shall be used in conjunction with the Tree Data. Specific information regarding tree species, condition, and protection protocols are listed therein.
- The Minimum Tree Protection Zones (mTPZ) are shown on the plan. Tree protection fencing has been determined based on these values. These zones represent off-limits areas for all construction activities. The project arborist, if designated, will determine final approval of all tree protection requirements.
- Refer to the Tree Data and project arborist, if designated, for specific instructions regarding tree protection requirements for this project.

TREE DATA

Tree Preservation Plan Prepared By:
Shawn W. Bruzda
Associate Consultant
ISA Certified Arborist® OH-1342A and
Tree Risk Assessment Qualified (TRAQ)

| No. | DATE | BY | REVISIONS | | | | | | |
|-----|------------|----------------|------------------------|--|--|--|--|--|--|
| 1 | 03/25/2025 | SWB | TREE PRESERVATION PLAN | | | | | | |
| | | | | | | | | | |
| | | | | | | | | | |
| | | <u>APPROVA</u> | LS STAMP | | | | | | |
| | INICIPAL | RING | | | | | | | |
| _ | | | | | | | | | |
| DAT | E | | | | | | | | |



CLIENT:

POD DESIGN, LLC

100 NORTHWOODS BOULEVARD, SUITE A COLUMBUS, OHIO 43235

SITE TITLE:

FAIRFAX PLACE
TRANSITIONAL CARE FACILITY
9014 CEDAR AVENUE
CLEVELAND, OHIO 44106

DRAWING NO.:

TPP - 1

SHEET SCALE:
N/A

CONTRACT NO.:

SHEET:
2 OF 3

TREE PRESERVATION SPECIFICATIONS

<u>NOTE:</u> SPECIFICATIONS 1 THROUGH 7 ARE TO BE FOLLOWED ON—SITE, AS REQUIRED. <u>SPECIFICATION 8 MUST BE FOLLOWED TO PREVENT DAMAGE TO ADJACENT STRUCTURES DURING DEMOLITION WORK.</u>

1. GENERAL

- 1.1. ALL MEASURES SHOULD BE INSPECTED AFTER INSTALLATION AND APPROVED BY CONTRACT ARBORIST, IF DESIGNATED.
- 1.2. SUBSTITUTIONS OR ALTERNATIVE METHODS OR MATERIALS SHOULD BE REVIEWED AND APPROVED BY CONTRACT ARBORIST, IF DESIGNATED.
- 1.3. ALL TREE PROTECTION MEASURES SHOULD BE IN PLACE PRIOR TO COMMENCEMENT OF DEMOLITION, SITE CLEARING, OR CONSTRUCTION AND MAINTAINED THROUGHOUT CONSTRUCTION. TREE PROTECTION MEASURES SHOULD ONLY BE REMOVED WITH CONTRACT ARBORIST APPROVAL. IF DESIGNATED.
- 1.4. REFER TO THE TREE DATA FOR SPECIFIC RECOMMENDATIONS FOR EACH TREE.

2. TREE PROTECTION FENCE

- 2.1. INSTALL PRIOR TO CLEARING & GRADING.
- 2.2. FENCE SHOULD BE MESH SNOW FENCE FABRIC MOUNTED ON 8', 1.5"Ø GALVANIZED STEEL PIPE LINE POSTS OR ALTERNATE. CORNER POSTS SHALL BE 2"Ø OR ALTERNATE (SEE DETAIL). FOR ALTERNATES, SEE SHEET 4 NOTE 2.
- 2.3. FENCE SHALL BE ATTACHED TO POSTS USING NYLON CABLE TIES.
- 2.4. TREE PROTECTION AREA SIGNS SHOULD BE ATTACHED TO ALL TREE PROTECTION FENCE AT 30' SPACING AVERAGE. SIGNS SHALL NOT BE AFFIXED DIRECTLY TO TREES (SEE DETAIL).
- 2.5. ALL SILT FENCE SHOULD BE COORDINATED FOR INSTALLÁTION TO ENHANCE PROTECTION AND AVOID UNNECESSARY ROOT CUTS BY SILT FENCE INSTALLATION.
- 2.6. TREE PROTECTION FENCE MAY BE REMOVED ONLY AFTER ALL CONSTRUCTION AND FINAL LANDSCAPING IS COMPLETE.
- 3. <u>CONSTRUCTION MONITORING/INSPECTIONS</u>
 3.1. THE CONTRACT ARBORIST, IF DESIGNATED, SHOULD MAKE REGULAR WEEKLY INSPECTIONS DURING ACTIVE CONSTRUCTION AND DEMOLITION AND PROVIDE REPORTS TO THE CLIENT. REPORTS SHOULD DOCUMENT CONDITION OF TREE PROTECTION DEVICES AND PROVIDE RECOMMENDATIONS FOR MAINTENANCE AND/OR ADDITIONAL CARE.

4. MISCELLANEOUS TREE PROTECTION REQUIREMENTS

- 4.1. NO TOXIC MATERIALS SHALL BE STORED WITHIN 100' OF TREE PROTECTION AREAS.
- 4.2. ALL WORK IN OR NEAR TREE PROTECTION AREAS SHALL BE PERFORMED IN A MANNER TO MINIMIZE DAMAGE TO TREES, SHRUBS, GROUND COVER, SOIL AND ROOT SYSTEMS.
- 4.3. MECHANIZED EQUIPMENT SHALL NOT BE PERMITTED TO ENTER ANY TREE PROTECTION AREAS (TPAS).

5. SPECIAL BY HAND DEMOLITION AND CONSTRUCTION PROCEDURES

- 5.1. DEMOLITION AND CONSTRUCTION OF IMPROVEMENTS WITHIN TREE PROTECTION AREAS SHOULD BE PERFORMED UNDER
- CONTRACT ARBORIST SUPERVISION, IF DESIGNATED.
 5.2. MECHANIZED EQUIPMENT SHALL NOT ENTER THE TPAS.
- 5.3. BACKFILL OF VOIDS FROM DEMOLITION WITHIN THE TPAS SHALL BE LOOSELY PLACED TOPSOIL. ONLY THE AMOUNT OF SOIL NECESSARY TO FILL THE VOID WITHOUT SPREADING OVER EXISTING ADJACENT GRADES SHALL BE ALLOWED.
- 5.4. ROOTS ENCOUNTERED DURING DEMOLITION OR EXCAVATION SHALL BE REVIEWED ON A CASE—BY—CASE BASIS BY CONTRACT ARBORIST, IF DESIGNATED. CONTRACT ARBORIST, IF DESIGNATED, SHALL PROVIDE APPROPRIATE TREATMENT OR PRUNING METHODS AS NEEDED AND IN GENERAL CONFORMANCE WITH ACCEPTED INDUSTRY STANDARDS AND THIS SECTION. ROOTS OVER 1"0 SHOULD NOT BE CUT WITHOUT CONTRACT ARBORIST APPROVAL, IF DESIGNATED.
- 5.5. DEMOLITION AND CONSTRUCTION OF ANY PROPOSED SIDEWALK SHOULD FOLLOW ANY LOCAL REGULATIONS FOR SIDEWALK CONSTRUCTION WITHIN TREE PROTECTION ZONES, INCLUDING NO TO MINIMAL EXCAVATION.

6. TREE CONDITION MONITORING INSPECTIONS

- 6.1. CONTRACT ARBORIST, IF DESIGNATED, SHALL PROVIDE MONITORING OF THE CONDITION OF RETAINED TREES IN TREE PROTECTION AREAS, AND TREATMENT OF DETRIMENTAL CONDITIONS (INSECTS, DISEASES, NUTRIENT DEFICIENCIES, SOIL MOISTURE, ETC.), AS THEY OCCUR, OR AS APPROPRIATE FOR EFFECTIVE MANAGEMENT.
- 6.2. INSPECTIONS SHALL BE PERFORMED AT LEAST MONTHLY DURING THE GROWING SEASON, BEGINNING PRIOR TO CONSTRUCTION AND CONTINUING THROUGHOUT CONSTRUCTION AND FOR AT LEAST ONE YEAR SUBSEQUENT TO COMPLETION OF CONSTRUCTION ACTIVITIES.
- 6.3. A WRITTEN SUMMARY REPORT INCLUDING SPECIFIC TREATMENTS MADE AND RECOMMENDATIONS FOR ADDITIONAL TREATMENTS SHALL BE PROVIDED TO THE CLIENT BY THE CONTRACT ARBORIST, IF DESIGNATED, SUBSEQUENT TO EACH

INSPECTION. 7. SSAT EXCAVATION WITHIN CRZS

- 7.1. PROPOSED DRY UTILITIES, LIGHTING CONDUITS, HARDSCAPE, OR SPRINKLERS WITHIN TREE PROTECTION AREAS (TPAS)
 SHOULD BE EXCAVATED BY SUPERSONIC AIRTOOL (SSAT) TO MINIMIZE DAMAGE TO ROOT SYSTEMS.
- 7.2. CLIENT, CONTRACTOR, CONTRACT ARBORIST, IF DESIGNATED, AND CITY SHALL REVIEW THE PROPOSED LOCATION(S)
 DURING THE PRE—CONSRUCTION MEETING.
- 7.3. PRE—WATERING OF THE PROPOSED AREAS OF EXCAVATION DURING SUMMER AND FALL MONTHS IS RECOMMENDED TO MAINTAIN ROOT / SOIL MOISTURE.
- 7.4. CONTRACT ARBORIST, IF DESIGNATED, SHALL PROVIDE A QUALIFIED ARBORIST CREW, IF DESIGNATED, EXPERIENCED WITH THE SSAT AND UTILITY EXCAVATION TO PROTECT ADJACENT TREES, OPEN THE EXCAVATION, HAND PRUNE MINOR ROOTS, AND IDENTIFY AND PROTECT PRIORITY ROOTS TO REMAIN. COORDINATION WITH THE APPROPRIATE SUB—CONTRACTOR SHALL BE MADE TO DETERMINE APPROPRIATE WIDTH, DEPTH & SEQUENCING, UTILITY INSTALLATION, BACKFILL, COMPLETION. AND COVER.

8. <u>TREE REMOVALS</u>


- 8.1. ALL TREES DESIGNATED FOR REMOVAL SHALL BE TAKEN DOWN SECTIONALLY OR DIRECTIONALLY FELLED BY A QUALIFIED CONTRACT ARBORIST, IF DESIGNATED, TO MINIMIZE DAMAGE TO ADJACENT TREE CANOPIES, ROOT SYSTEMS AND EXISTING STRUCTURES TO REMAIN. GOUGES IN TURF FROM IMPACTS SHOULD BE FILLED WITH TOPSOIL AND SEEDED AT DIRECTION OF PROJECT ARBORIST, IF DESIGNATED. DAMAGE TO ADJACENT TREES SHALL BE REVIEWED BY PROJECT ARBORIST, IF DESIGNATED. FOR REMEDIAL RECOMMENDATIONS OR REPLACEMENT.
- BESIGNATED, FOR REMEDIAL RECOMMENDATIONS OR REPLACEMENT.

 8.2. ALL WORK SHALL BE DONE BY HAND, BUCKET TRUCK OR CRANE OPERATED EQUIPMENT.
- 8.3. MOTORIZED EQUIPMENT SHALL OPERATE ON EXISTING PAVEMENT AND NOT ENTER TREE PRESERVATION AREAS WITHOUT PRIOR APPROVAL. TEMPORARY ROOT PROTECTION MATTING MAY BE REQUIRED FOR SUCH ACCESS TO PREVENT RUTTING AND COMPACTION.
- 8.4. STUMPS SHALL BE GROUND TO 6" BELOW GRADE AND GRINDINGS RAKED AND REMOVED FROM SITE; BACKFILL HOLES WITH APPROVED TOPSOIL. COORDINATE WITH UNDERGROUND UTILITIES LOCATORS PRIOR TO STUMP GRINDING.

IMPORTANT TREE PROTECTION/REMOVAL REQUIREMENTS:

APPLICABLE CODIFIED ORDINANCES OF THE CITY OF CLEVELAND, OHIO (CURRENT THROUGH LEGISLATION PASSED 3 MARCH 2025) CONCERNING THIS TREE PRESERVATION PLAN: CHAPTER 341 — DESIGN REVIEW (SECTION 341.051 TREE PRESERVATION PLAN REQUIRED); CHAPTER 509 — TREES (SECTION 509.02 KILLING, REMOVING TREES PROHIBITED; EXCEPTIONS; PERMIT and SECTION 509.14 PROTECTING TREES DURING CONSTRUCTION and SECTION 509.99 PENALTY [SEE (a-c), (d:1-3) and (e) and (g)]

- 1. ACCESSED THROUGH: https://codelibrary.amlegal.com/codes/cleveland/latest/cleveland_oh/0-0-0-1 ACCESSED ON 25 MARCH 2025
- 2. CODIFIED ORDINANCES OF THE CITY OF CLEVELAND, OHIO DISCLAIMER: This Code of Ordinances and/or any other documents that appear on this site may not reflect the most current legislation adopted by the Municipality. American Legal Publishing provides these documents for informational purposes only. These documents should not be relied upon as the definitive authority for local legislation. Additionally, the formatting and pagination of the official printed copy of a Code of Ordinances should be consulted prior to any action being taken. For further information regarding the official version of any of this Code of Ordinances or other documents posted on this site, please contact the Municipality directly or contact American Legal Publishing toll—free at 800—445—5588 (website: www.amlegal.com).
- 3. TREE #'s 31-35 ARE PUBLIC STREET TREES OWNED BY THE CITY OF CLEVELAND AND PROTECTED UNDER CODIFIED ORDINANCES OF THE CITY OF CLEVELAND, OHIO (COMPLETE THROUGH MAY 1, 2023), CHAPTER 509 TREES: SECTION 509.02 KILLING, REMOVING TREES PROHIBITED; EXCEPTIONS; PERMIT: No person, firm or corporation shall kill or remove, or cause, authorize or procure the death or removal of any tree planted or growing in any public highway within the City. Any person, firm or corporation desiring for any lawful purpose to take down or remove any tree in any public highway of the City may apply to the Director of Public Properties, and if in the judgment of the Director, the desired taking down or removal appears necessary, the Director may thereupon issue a written permit therefor. Any work done under such written permit must be performed in strict accordance with the terms thereof. CHAPTER 509 TREES: SECTION 509.99(c) PENALTY: Any person, firm or corporation which violates Sections 509.02, 509.04 or 509.10 shall be fined not more than one thousand dollars (\$1,000.00) for each offense.

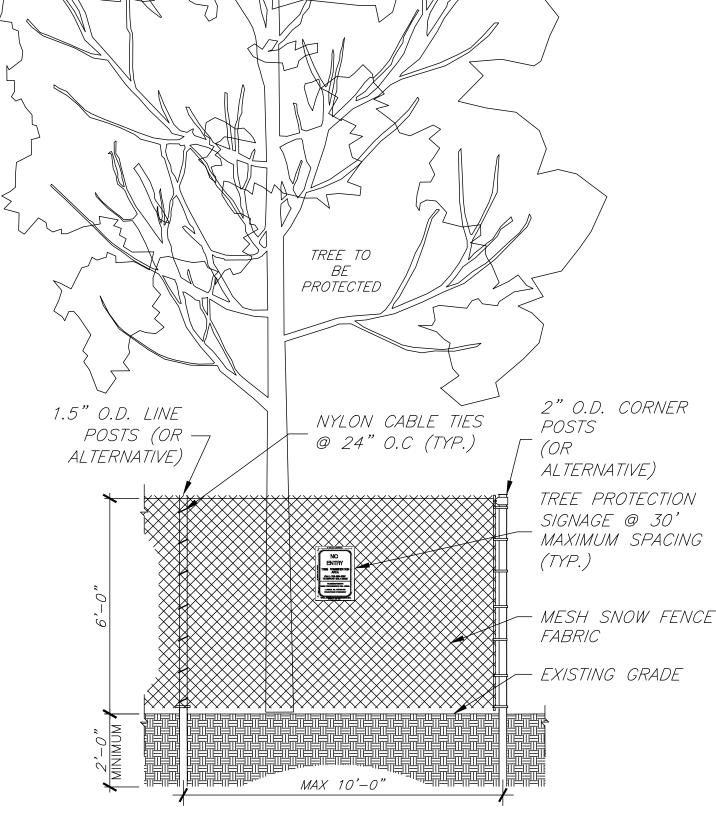

MATE

- 1. TREE PROTECTION FENCE SHALL BE INSTALLED PRIOR TO ANY SITE WORK, CLEARING OR
- 2. SUPER SILT FENCE/SNOW FENCE MAY BE USED IN LIEU OF WELDED WIRE FOR TREE PROTECTION PROVIDED IT IS INSTALLED AND MAINTAINED AS A TREE PROTECTION MEASURE AND IS POSTED WITH TREE PROTECTION SIGNS.
- 3. TREE PROTECTION FENCE SHALL BE MAINTAINED THROUGHOUT CONSTRUCTION. REMOVE FENCE ONLY WITH APPROVAL AND AFTER ALL SITE WORK HAS BEEN COMPLETED.



SUMMARY NOTE

- 1. INSTALL TREE PROTECTION FENCE AND PERFORM ROOT PRUNING PER PLAN FOR ALL PROTECTED TREES PRIOR TO ANY DEMOLITION OR CONSTRUCTION ACTIVITY.
- 2. FENCE THE PUBLIC PORTION (PARKWAYS) OF THE ENTIRE TREE PROTECTION ZONE(S) TO PREVENT WOUNDS TO THE PARKWAY TREES(S) AS WELL AS SOIL COMPACTION. POST THE FENCE WITH A SIGN STATING "TREE PROTECTION ZONE KFFP OUT"
- 3. NO TRENCHING SHOULD BE DONE WITHIN THE TREE PROTECTION ZONES (TPZ) FOR ANY CONSTRUCTION ACTIVITY UNLESS
- 4. NO GRADE CHANGES SHOULD BE DONE WITHIN THE TREE PROTECTION ZONES OF PARKWAY TREES FOR ANY CONSTRUCTION ACTIVITY.
- 5. LOCATE THE PROPOSED WATER AND SEWER LINES OUTSIDE OF THE TREE PROTECTION ZONE OR INSTALL THE UTILITIES USING TRENCH—LESS METHODS. IF AT ANY TIME TWENTY—FIVE PERCENT (25%) OF THE AREA WITHIN THE TPZ IS BEING SEPARATED FROM THE TREE BY A TRENCH, THEN THE LINE SHOULD BE EITHER RELOCATED OR INSTALLED USING TRENCH—LESS METHODS.
- 6. SHOULD IT BE NECESSARY TO EXCAVATE WITHIN THE TPZ FOR DISCONNECTION OR CAPPING OF EXISTING UTILITIES, ALL TRENCHES SHOULD BE HAND DUG. NO ROOTS LARGER THAN TWO INCHES (2") SHALL BE CUT UNLESS NO OTHER ALTERNATIVE IS FEASIBLE. ALL SMALLER ROOTS THAT REQUIRE CUTTING SHALL BE CUT WITH PRUNING SAWS. CUTS SHALL BE MADE FLUSH WITH THE TREE SIDE OF THE EXCAVATION.
- 7. REMOVAL OF ANY HARDSCAPE WITHIN THE TREE PROTECTION ZONES SHOULD BE DONE BY HAND. NO ROOTS LARGER THAN TWO INCHES (2") SHALL BE CUT UNLESS NO ALTERNATIVE IS FEASIBLE. CUTS WILL BE MADE WITH A SHARP PRUNING SAW TO AVOID TEARING AND WILL BE FLUSH WITH THE TREE SIDE OF THE TRENCH.
- 8. AT NO TIME SHALL ANY EQUIPMENT, MATERIALS, SUPPLIES OR FILL SOIL BE ALLOWED IN THE TREE PROTECTION ZONE(S).

 DO NOT STORE EXCAVATED SOIL, BUILDING MATERIALS OR A DUMPSTER WITHIN THE DRIP—LINE (TPZ) OF THE PARKWAY

 TREE(S)
- 9. THE TREE PROTECTION ZONES MAY BE MULCHED TO IMPROVE THE GROWING CONDITIONS FOR TREE ROOTS, AND MINIMIZE THE MAINTENANCE OF THE PARKWAY LAWN.
- 10. ALL WORK SHOULD BE PERFORMED ACCORDING TO THE TREE PRESERVATION PLAN. 11. THE APPROVED TREE PRESERVATION PLAN MUST BE AVAILABLE AT THE CONSTRUCTION SITE.
- 12. ALL REQUIRED TREE PROTECTION FENCING SHALL REMAIN IN PLACE UNTIL THE TIME OF FINAL GRADING AND LANDSCAPING.
 **TREE PROTECTION ZONE (TPZ) IS THE DESIGNATED AREA THAT ENCOMPASSES AN ENTIRE TREE CANOPY.

ADDITIONAL NOTES:

- 1. TREE LOCATIONS MAY BE APPROXIMATE. CLIENT AND CONTRACT ARBORIST SHOULD VERIFY ALL TREE LOCATIONS AND CONDITIONS PRIOR TO CONSTRUCTION AND/OR TREATMENT OR REMOVAL.
- 2. A PRE-CONSTRUCTION MEETING SHOULD BE HELD PRIOR TO COMMENCEMENT OF DEMOLITION/CONSTRUCTION ACTIVITY. CITY, CLIENT, DESIGN TEAM MEMBERS (PROJECT ARBORIST, LANDSCAPE ARCHITECT, ENGINEER, ARCHITECT, ETC.), CONTRACT ARBORIST, SITE AND LANDSCAPE CONTRACTORS SHOULD ATTEND.
- 3. THE INSPECTION OF THESE TREES CONSISTED SOLELY OF A VISUAL INSPECTION FROM THE GROUND. WHILE MORE THOROUGH TECHNIQUES ARE AVAILABLE FOR INSPECTION AND EVALUATION, THEY WERE NEITHER REQUESTED NOR CONSIDERED NECESSARY OR APPROPRIATE AT THIS TIME.
- 4. TREES RATED "POOR" OR "DEAD" THAT ARE NOT RECOMMENDED FOR REMOVAL DUE TO CONSTRUCTION IMPACT MAY WARRANT FURTHER EVALUATION AND/OR TREATMENT OR REMOVAL.

NOT

- All base map information has been supplied by the client.
- All field data were collected by Lizzie Sords, ISA Certified Arborist®
 PN8706-A, Tree Risk Assessment Qualified (TRAQ), on 12 March 2025. All
 tree locations are based on the survey map supplied by the client and field
 data collected by the arborist.
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 zones represent off-limits areas for all construction activities. The project
 arborist, if designated, will determine final approval of all tree protection
 requirements.
- Refer to the Tree Data and project arborist, if designated, for specific instructions regarding tree protection requirements for this project.

Tree Preservation Plan Prepared By:
Shawn W. Bruzda
Associate Consultant
ISA Certified Arborist® OH-1342A and
Tree Risk Assessment Qualified (TRAQ)

| No. | DATE | BY | REVISIONS |
|-----|------------------|---------|------------------------|
| 1 | 03/25/2025 | SWB | TREE PRESERVATION PLAN |
| | | | |
| | | | |
| | | APPROVA | LS STAMP |
| | INICIPAL | DINO. | |
| DAT | CTOR OF ENGINEER | KING | |



CLIENT:

POD DESIGN, LLC

100 NORTHWOODS BOULEVARD, SUITE A

COLUMBUS, OHIO 43235

SITE TITLE:


FAIRFAX PLACE TRANSITIONAL CARE FACILITY 9014 CEDAR AVENUE


CLEVELAND, OHIO 44106


DRAWING NO.:
TPP - 1

SHEET SCALE:
N/A

CONTRACT NO.:
SHEET:
3 OF 3

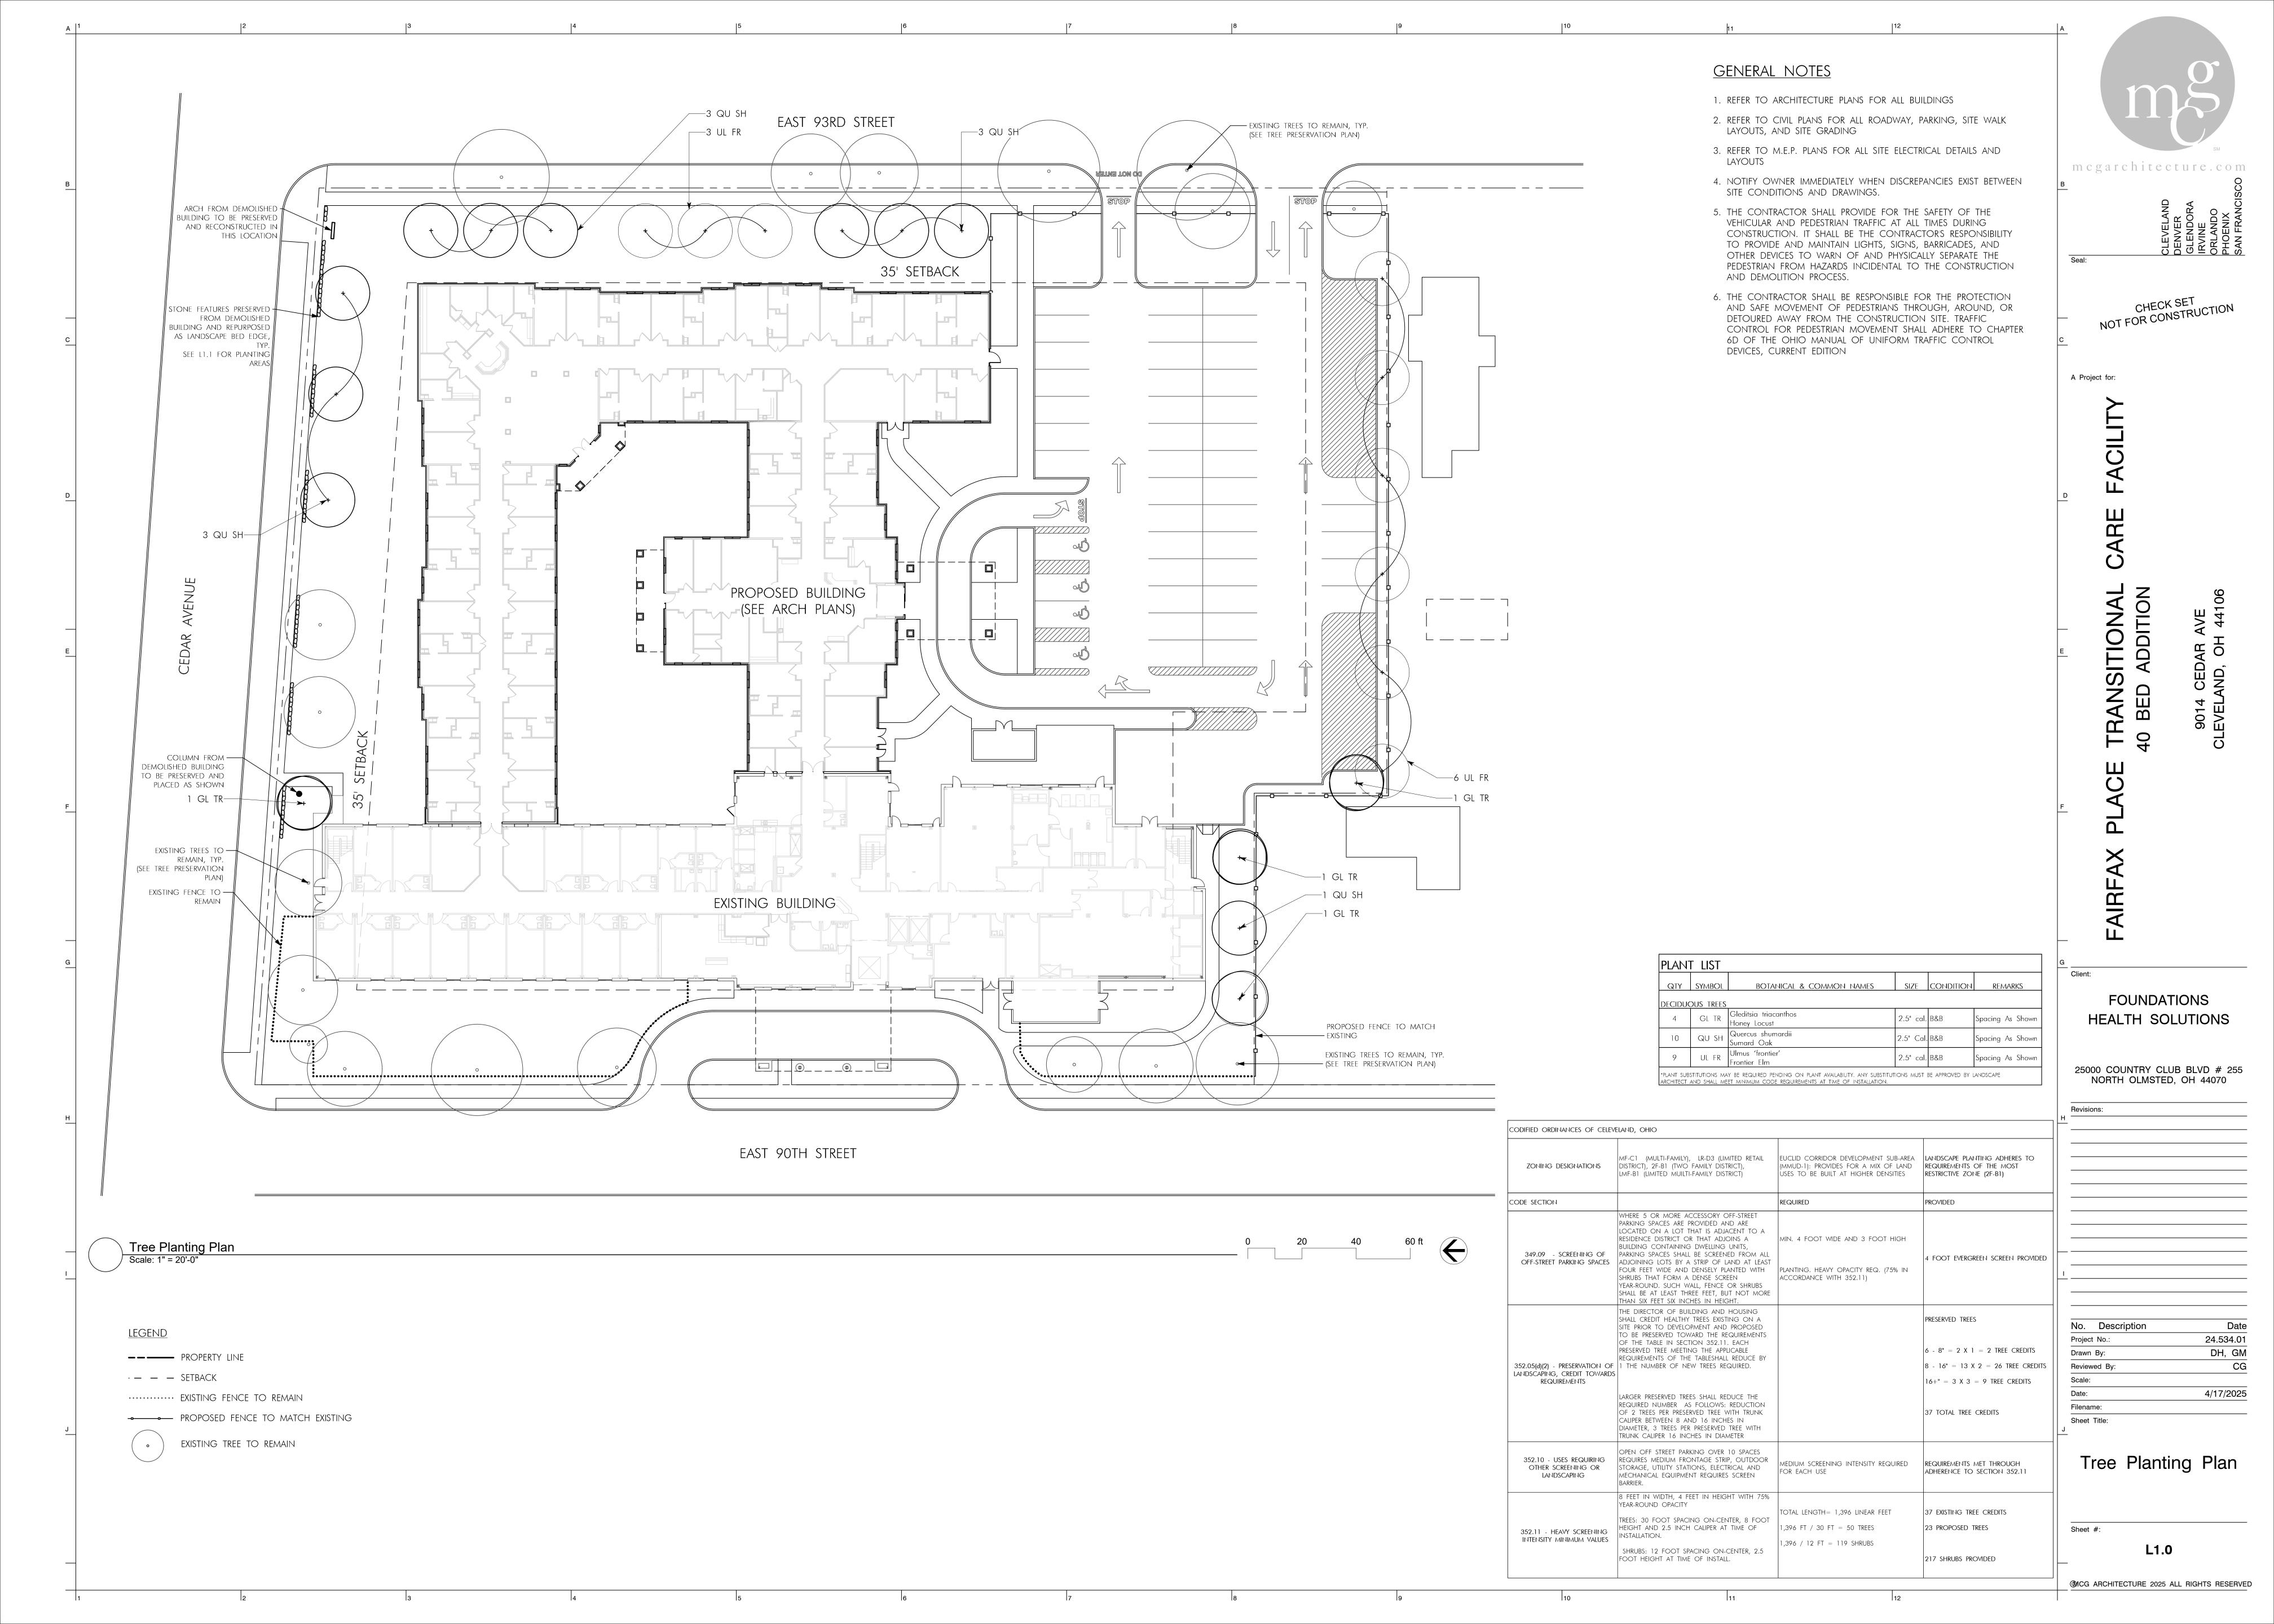

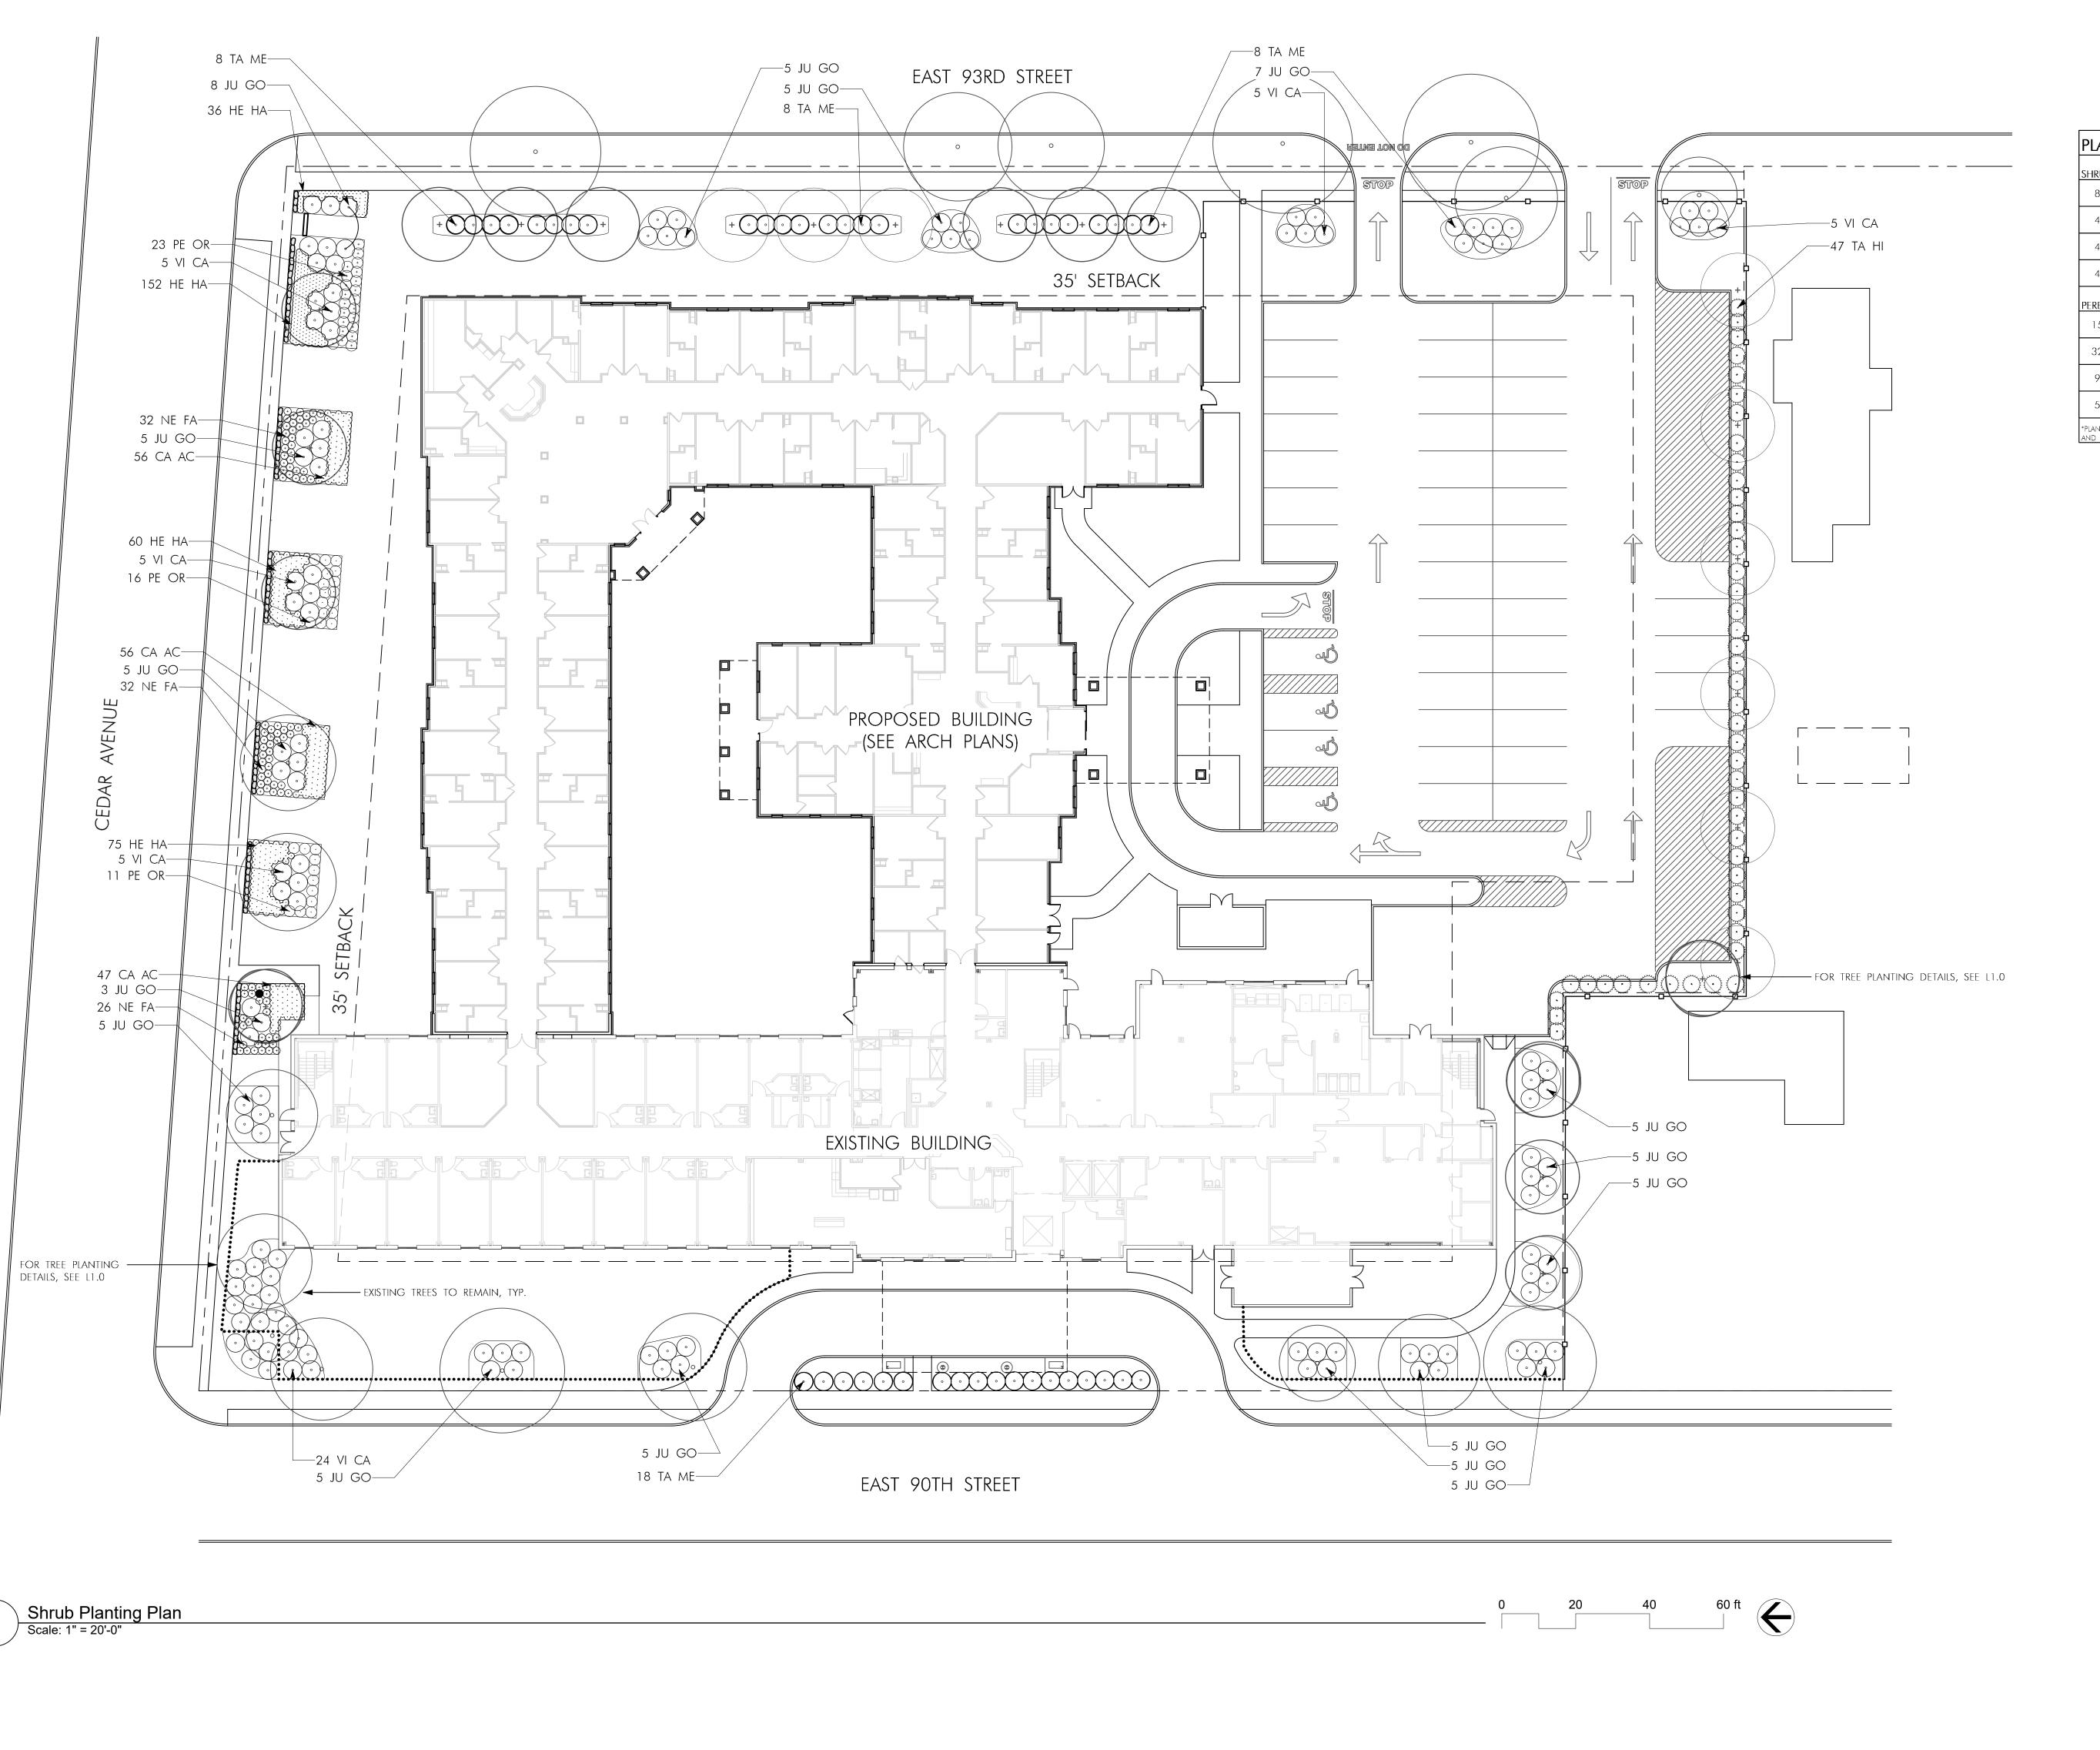

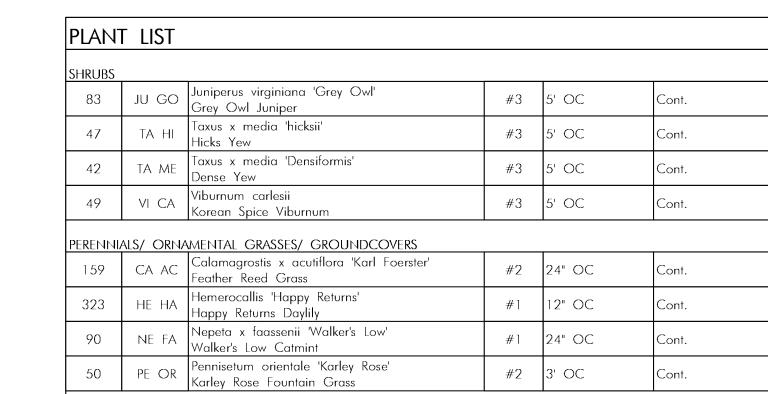

*PLANT SUBSTITUTIONS MAY BE REQUIRED PENDING ON PLANT AVAILABILITY. ANY SUBSTITUTIONS MUST BE APPROVED BY LANDSCAPE ARCHITECT AND SHALL MEET MINIMUM CODE REQUIREMENTS AT TIME OF INSTALLATION.

CLEVELAND
DENVER
GLENDORA
IRVINE
ORLANDO
PHOENIX
SAN FRANCISCO

CHECK SET NOT FOR CONSTRUCTION

A Project for:

CARE FACILITY

CE

TRANSITIONAL C
40 BED ADDITION
9014 CEDAR AVE

FOUNDATIONS
HEALTH SOLUTIONS

25000 COUNTRY CLUB BLVD # 255 NORTH OLMSTED, OH 44070

No. Description

Project No.:

24.534.01

Drawn By:

DH, GM

Reviewed By:

CG

Scale:

Date:


4/17/2025

Filename:

Shrub Planting Plan

L1.1


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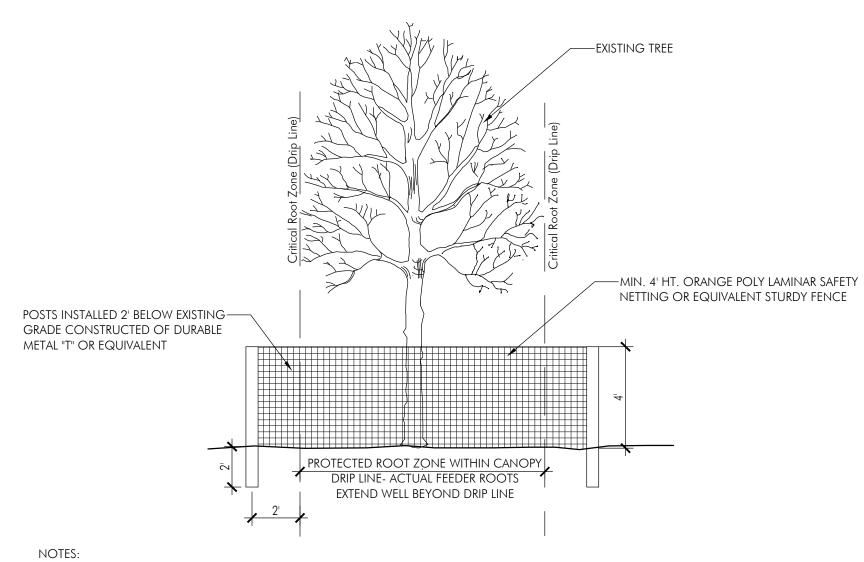
Tree Planting
N.T.S.

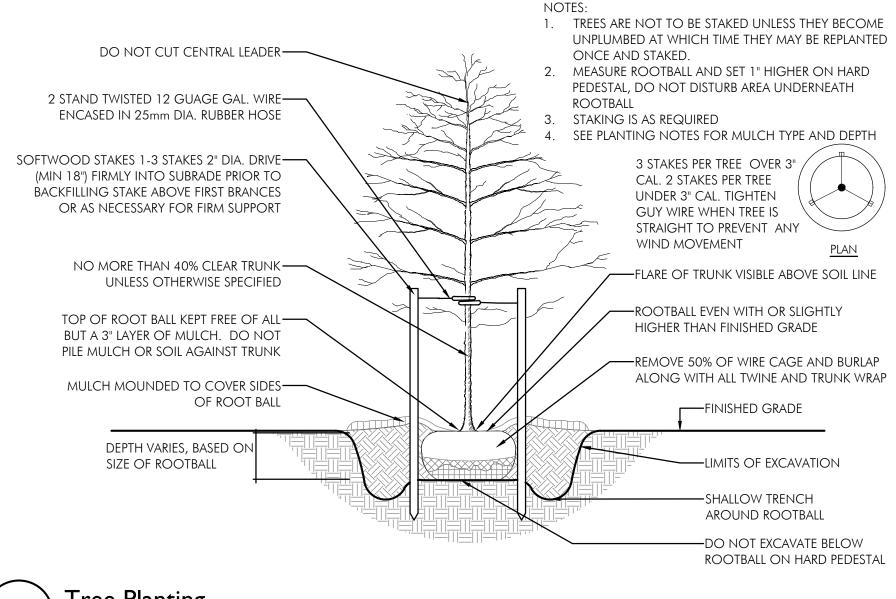DO NOT PRUNE SHRUBS DURING INSTALLATION
 MEASURE ROOTBALL AND SET 1" HIGHER ON HARD PEDESTAL, DO NOT DISTURB AREA UNDERNEATH ROOTBALL
 SEE PLANTING NOTES FOR MULCH TYPE AND DEPTH

THE AMOUNT OF PRUNING SHALL BE LIMITED TO 1/3 OF THE BRANCHES TO COMPENSATE FOR LOSS OF ROOTS FROM TRANSPLANTING. REMOVE DEAD AND INJURED LIMBS. REMOVE BURLAP AND WIRE OR TWINE FROM TOP AND SIDES OF BALL. CENTER SHRUB IN HOLE. SET TOP OF BALL 1-3" ABOVE FINISH GRADE.




Shrub Planting

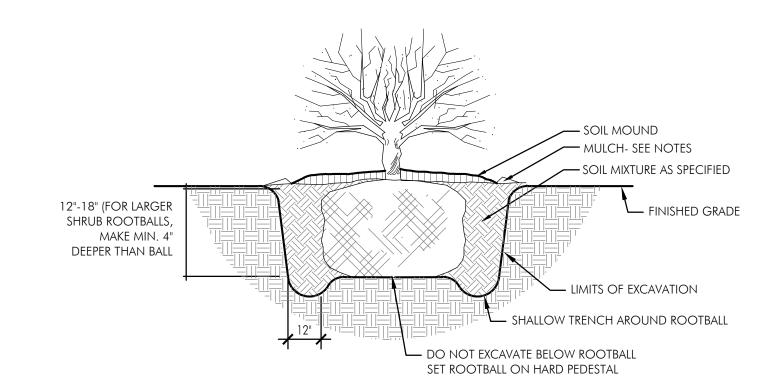

NOTES:
CONSTRUCTION FENCE TO BE INSTALLED 2' BEYOND CRITICAL ROOT ZONE (DRIP LINE) OF TREE OR 15' FROM THE TRUNK, WHICHEVER IS GREATER NO CONSTRUCTION SHALL OCCUR WITHIN FENCE LIMITS, FENCING TO BE INSTALLED PRIOR TO CONSTRUCTION
AERATION OF ROOTS VIA SOIL INJECTION OF FERTILIZER TO BE PERFORMED PRIOR TO AND AFTER CONSTRUCTION

7 Tree Protection

NOTE: SEE PLANTING NOTES FOR MULCH TYPE AND DEPTH

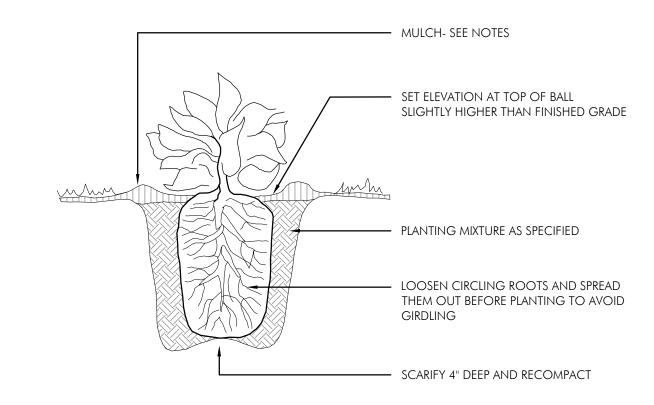

Perennial Planting
N.T.S.

<u>PLANT INSTALLATION NOTES</u>

(614) 645-3152

- 1. CONTRACTOR SHALL VERIFY WITH THE OWNER AND UTILITY COMPANIES THE LOCATIONS OF THE EXISTING UTILITIES PRIOR TO STARTING WORK. CALL THE VIRGINIA UTILITIES PROTECTION SERVICE AT (800) 552-3120. CONTRACTOR TO REPAIR ALL DAMAGES TO EXISTING UTILITIES, CURBS, PAVEMENTS, ETC. RESULTING FROM LANDSCAPE INSTALLATIONS WHICH OCCUR DURING THE CONSTRUCTION OF THE PROJECT.
- 2. Plant material shall be furnished in the quantities and/or spacing as shown or noted. In case of discrepancies between the plan and the plant list, the plan shall dictate.
- 3. CONTRACTOR SHALL VERIFY SIZES AND LOCATIONS OF ALL SITE ELEMENTS AND IMMEDIATELY INFORM THE OWNER AND THE LANDSCAPE ARCHITECT OF ANY DISCREPANCY BETWEEN THE DRAWINGS AND/OR SPECIFICATIONS AND ACTUAL CONDITIONS. NO WORK SHALL BE DONE IN ANY AREA WHERE THERE IS A DISCREPANCY WITHOUT OWNER'S APPROVAL.
- 4. CONTRACTOR SHALL BE RESPONSIBLE FOR ALL FINISH GRADING IN THE PROJECT REQUIRED TO PROVIDE A PROPER SOD AND PLANTING BED.
- 5. CONTRACTOR SHALL PROVIDE THE FOLLOWING SOIL AMENDMENTS:
 SOIL AMENDMENT: 'COM-TIL' ORGANIC COMPOST (OR EQUAL):
 7000 STATE ROUTE 104
 SOUTH LOCKBOURNE, OHIO 43137

PERENNIAL BED AREAS: SPREAD 3" OF 'COM-TIL' OVER NEW LANDSCAPE AREAS AND INCORPORATE INTO THE TOP 8" OF THE IMPORTED TOPSOIL BY MECHANICAL TILLER.

TREES AND SHRUBS: MIX 30% 'COM-TIL' TO 70% EXISTING SOIL FROM PLANT PIT EXCAVATION. IF EXCAVATED SOIL IS NOT SUITABLE, SUPPLEMENT WITH IMPORTED TOPSOIL.

- 6. ALL PLANT MATERIAL TO MEET OR EXCEED THE CURRENT AMERICAN STANDARD FOR NURSERY STOCK, ANSI Z60.1-2014, AS SET FORTH BY AMERICAN ASSOCIATION OF NURSERYMEN.
- 7. ALL SUBSTITUTIONS AND PLANT CHANGES MUST BE APPROVED BY THE OWNER AND LANDSCAPE ARCHITECT PRIOR TO ANY ACTION TAKEN. TREES SHALL BE PROTECTED AND HANDLED CAREFULLY AT ALL TIMES DURING TRANSPORT & HANDLING TO PREVENT DRYING OF TREE OR ROOT BALL BY WINDS AND TO PREVENT ANY DAMAGE OR BREAKAGE OF THE ROOT BALL. BARK SHALL BE PROTECTED FROM BRUISING OR ABRASION.
- 8. WATER ALL PLANTS IMMEDIATELY AFTER PLANTING AND CONTINUE TO WATER UNTIL FINAL ACCEPTANCE BY THE OWNER.
- 9. ALL SHRUB AND BED AREAS TO BE MULCHED WITH TWO INCHES (2") DEPTH MINIMUM SHREDDED HARDWOOD MULCH. SUBMIT SAMPLE TO OWNER FOR APPROVAL.
- 10.THE CONTRACTOR SHALL GUARANTEE ALL TREES, SHRUBS AND GROUND COVERS FOR A PERIOD OF ONE (1) YEAR FROM DATE OF FINAL ACCEPTANCE. REPLACE MATERIAL WITHIN SEVEN (7) DAYS OF NOTIFICATION OF THE OWNER.
- 11.PERFORM CLEANING DURING INSTALLATION OF LANDSCAPE WORK AND UPON COMPLETION. REMOVE FROM SITE ALL EXCESS LANDSCAPE RELATED MATERIAL, SOIL DEBRIS AND EQUIPMENT. REPAIR DAMAGE RESULTING FROM LANDSCAPING OPERATIONS. SWEEP AND HOSE DOWN PAVED SURFACES AFFECTED BY LANDSCAPING OPERATIONS. COORDINATE WITH OWNER AND OTHER CONTRACTORS FOR FINAL CLEANUP PRIOR TO CLEANING.
- 12.MAINTENANCE: THE LANDSCAPE CONTRACTOR SHALL MAINTAIN THE COMPLETED LANDSCAPE AND IRRIGATION SYSTEMS UNTIL THE DATE OF FINAL ACCEPTANCE.

A.MOWING - MINIMUM ONCE PER WEEK.

- B.TRIMMING SHRUBS, TREES, AND GROUND COVERS MINIMUM TWO TIMES PER YEAR OR AS REQUIRED.

 C.FERTILIZING APPLY FERTILIZER AT A RATE EQUAL TO 1 LB. OF ACTUAL NITROGEN/1000 S.F. IN THE SPRING AND FALL TO ALL TURF AND PLANTINGS.
- D.BED EDGING EDGE ALL BEDS BY HAND, SPADE AT LEAST TWO TIMES PER YEAR AND TOP-MULCH WITH DRESS WOOD MULCH IN FALL AND SPRING.
- 13.ALL PLANT MATERIALS SUBJECT TO INSPECTION PRIOR, DURING AND AFTER INSTALLATION. ANY PLANT NOT MEETING THE REQUIREMENTS WILL BE CAUSE FOR REJECTION BY THE OWNER. ALL REJECTED PLANTS SHALL BE IMMEDIATELY REMOVED AND DISPOSED OF BY THE CONTRACTOR AND THE REPLACEMENT MATERIAL SHALL BE PROVIDED.
- 14.BED LINE TO BE 18" FROM BASE OF PLANT MATERIAL UNLESS OTHERWISE INDICATED ON THE DRAWINGS.

15.CONTACT THE OWNER TO REQUEST ELECTRONIC FILES FOR LAYOUT AND STAKING.

- 16.FINISHED TURF (SOD) TO BE FLUSH WITH TOP OF ADJACENT CURB OR WALK. COORDINATE WITH OWNER IN FIELD AS REQUIRED.
- 17.PLANT LOCATIONS AND BEDS SHALL BE LOCATED BY CONTRACTOR AND APPROVED BY OWNER AND LANDSCAPE ARCHITECT PRIOR TO PLANT INSTALLATION.

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A Project for:

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FAIRFAX PLACE

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| | Client: | |

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| HEALTH | SOLUTIONS |

25000 COUNTRY CLUB BLVD # 255 NORTH OLMSTED, OH 44070

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| No. Description | Date |
|-----------------|----------|
| Project No.: | 24.534.0 |
| rawn By: | DH, GN |
| Reviewed By: | CC |
| Scale: | |
| Oate: | 4/17/202 |
| ïlename: | |
| | |

Planting Details

L2.0

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9014 CEDAR AVENUE

PetBOT Submission

Cedar Health Realty, LLC





The Gardens of Fairfax Healthcare Center Project Data

- Cedar Health Realty, LLC purchased the property this year (2024) with two primary structures (Formerly Fairfax Place Retirement Home).
- Cedar Health Realty, LLC is associated with Foundations Health Solutions, a leading Ohio long-term care provider, managing nearly 60 nursing homes specializing in physical therapy and skilled nursing.
- Ocedar Health Realty, LLC purchased the subject property located at 9014 Cedar Avenue in 2024. The property consists of two primary structures that together served as Fairfax Place Retirement Home for 98 residents. The original structure was constructed in 1891 with a later addition at the rear. The second structure was constructed in 1995.
- Cedar Health Realty, LLC is currently engaged in renovating the 1995 structure to meet current standards for a nursing home and to update all interior finishes.
 - Cedar Health Realty, LLC is proposing the construction of a new addition to the 1995 structure that will provide 39 additional private rooms for the care of ventilator patients. The additional rooms provided in the addition will also serve to eliminate all but 6 of the current semi-private rooms and convert them to private occupancy.



Aerial Site Map - Existing Conditions



Street View - Existing Conditions



Cedar and E 90th




E 90th Rear Corner



Cedar and E 93rd



E 93rd Rear Corner

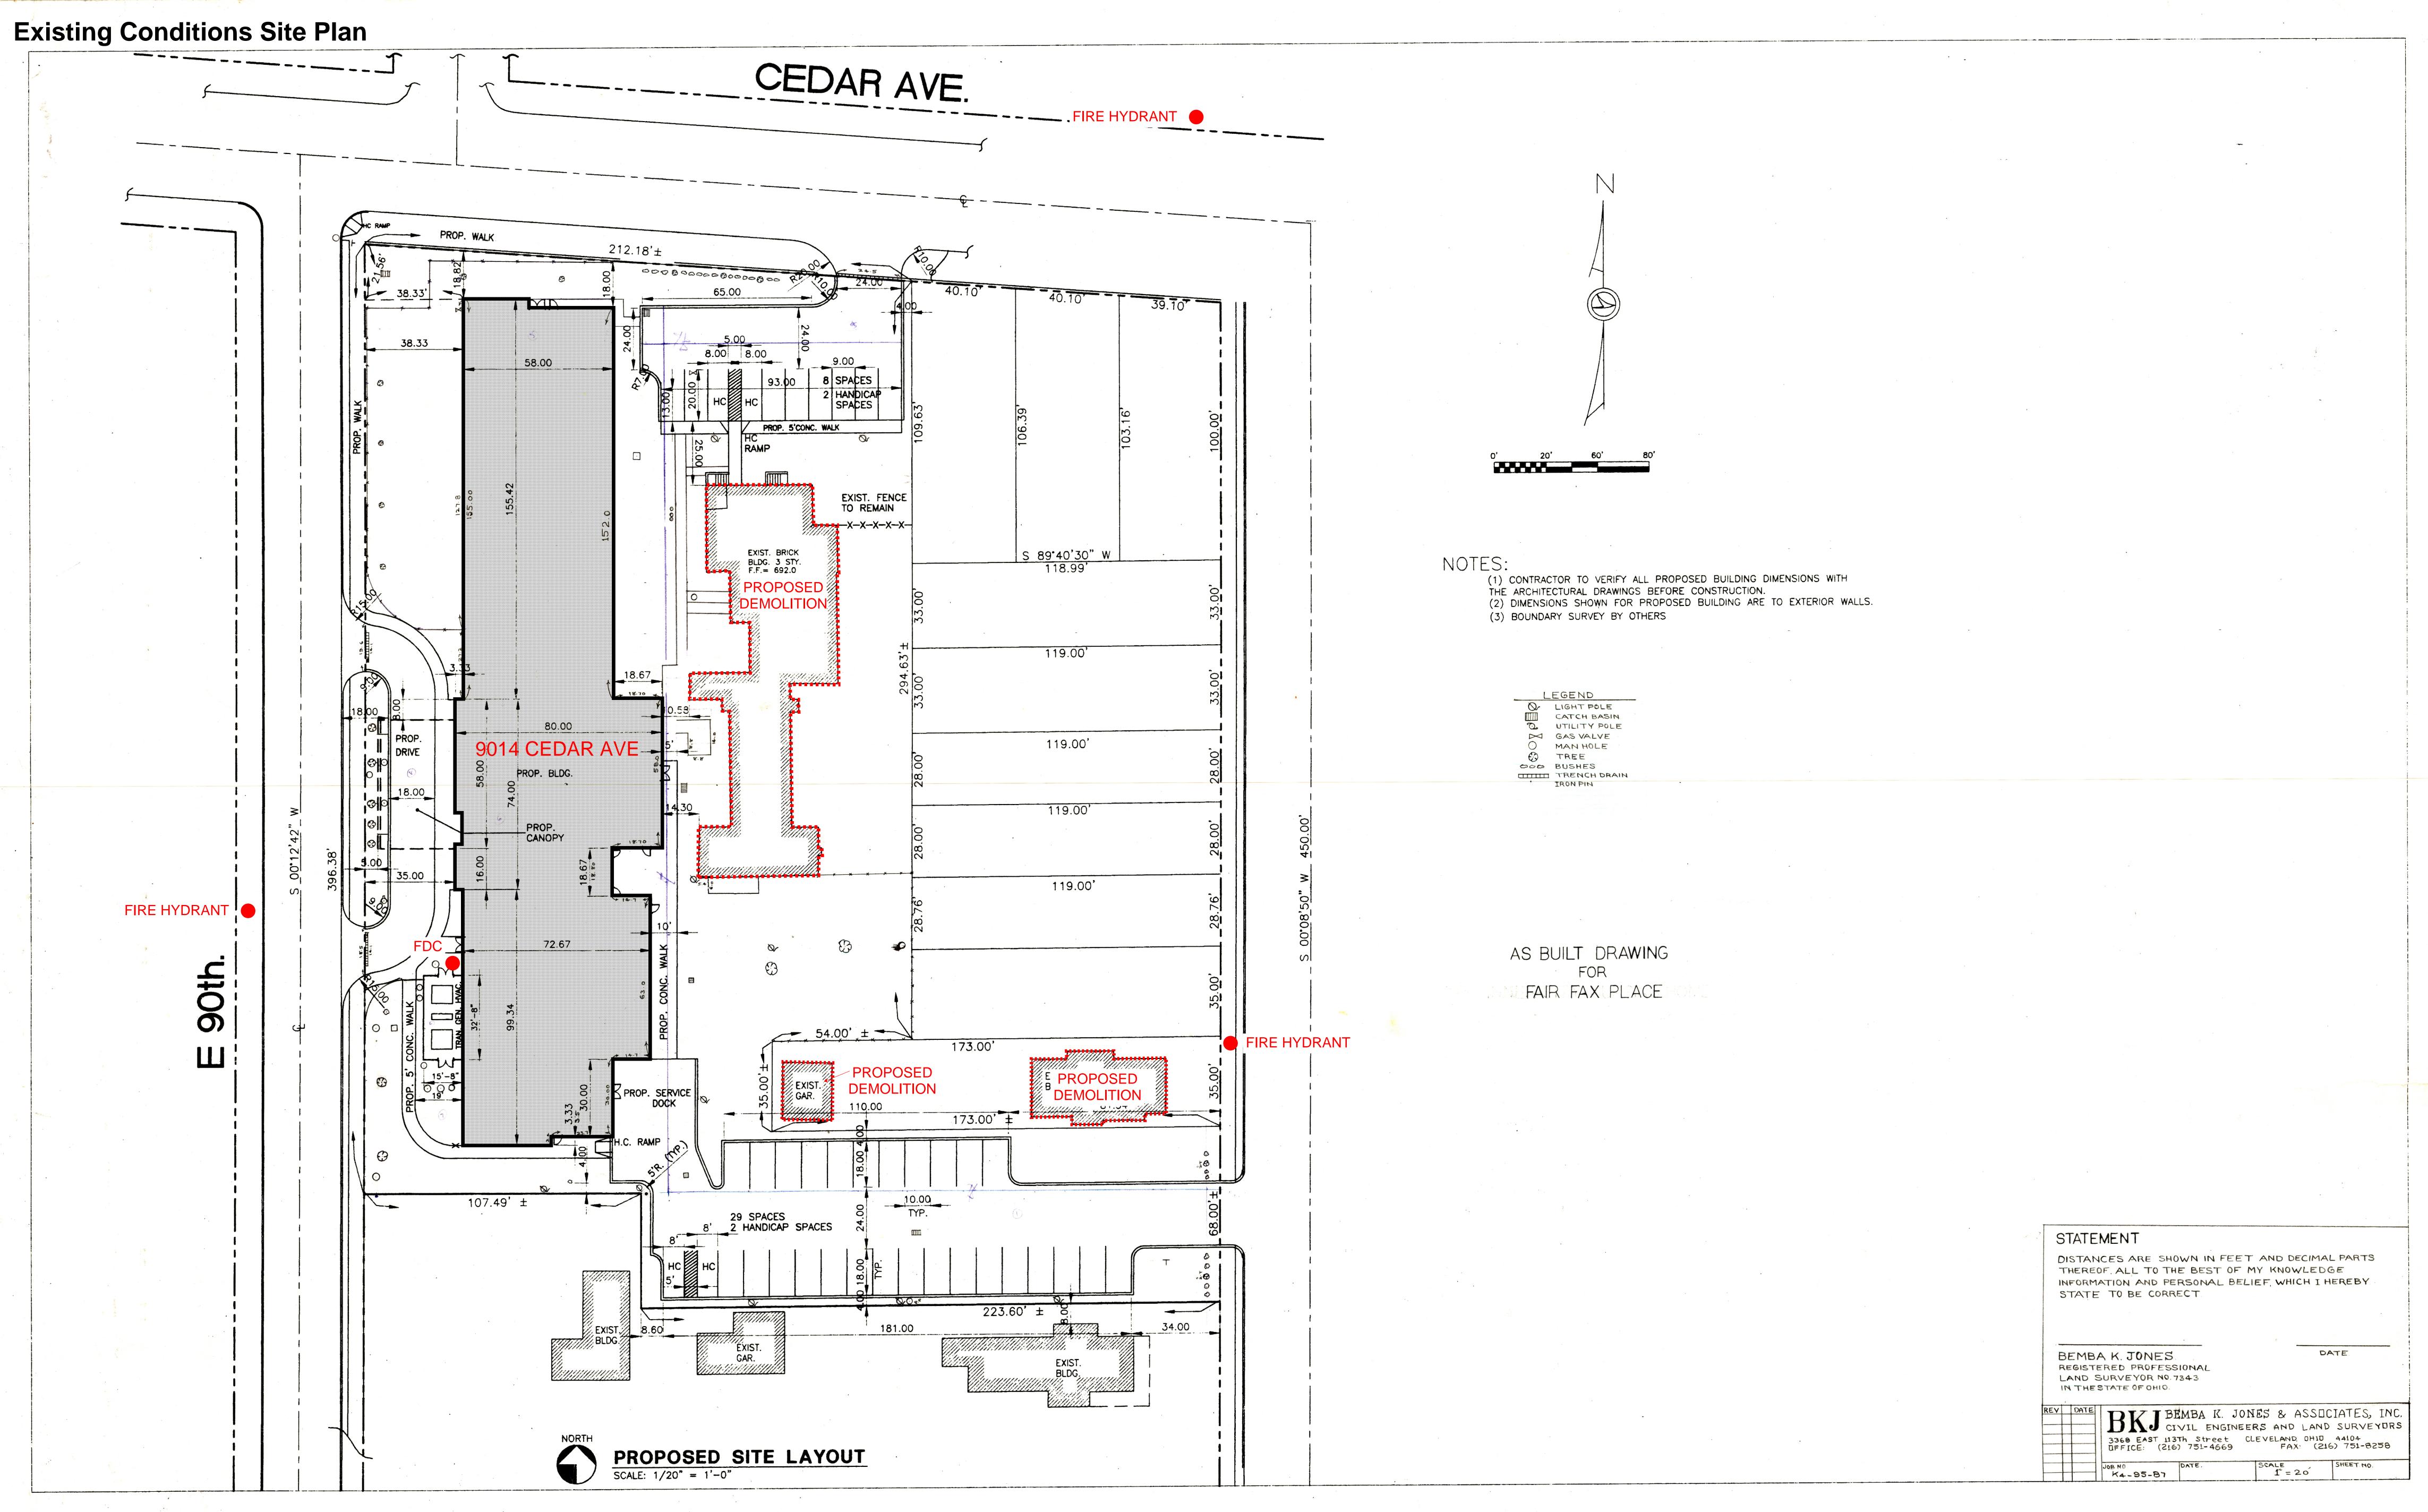



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Ralph Tyler Companies
Consulting Engineers and Archite
2143 States Boulevard Cleveland, Otto 44105-3035

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SITE LAYOUT PLAN



ARCHITECTURE INC.


3311 PERKINS AVENUE CLEVELAND, OHIO 44114 (216-881-2444)


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CHECKED BY: FR


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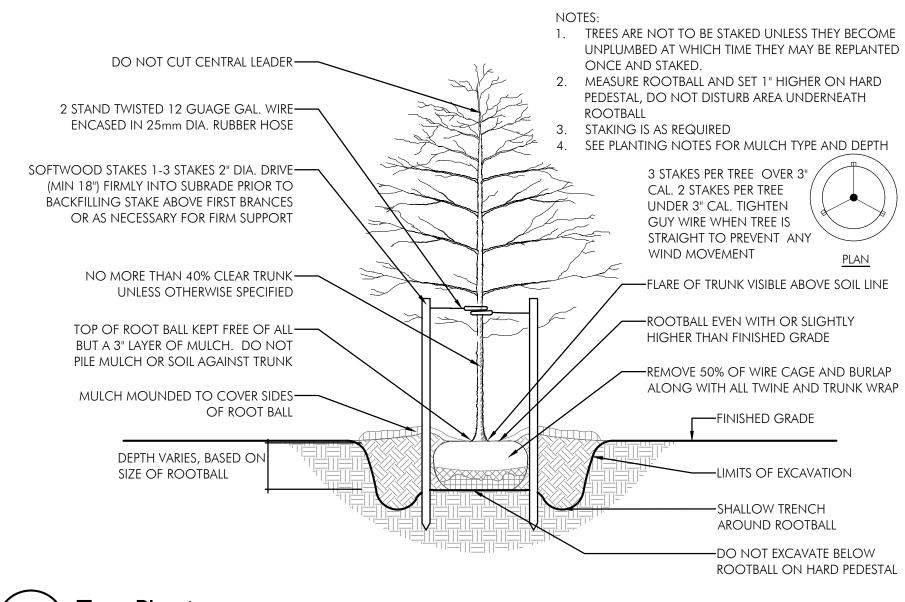
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Proposed Planting Details




Tree Planting

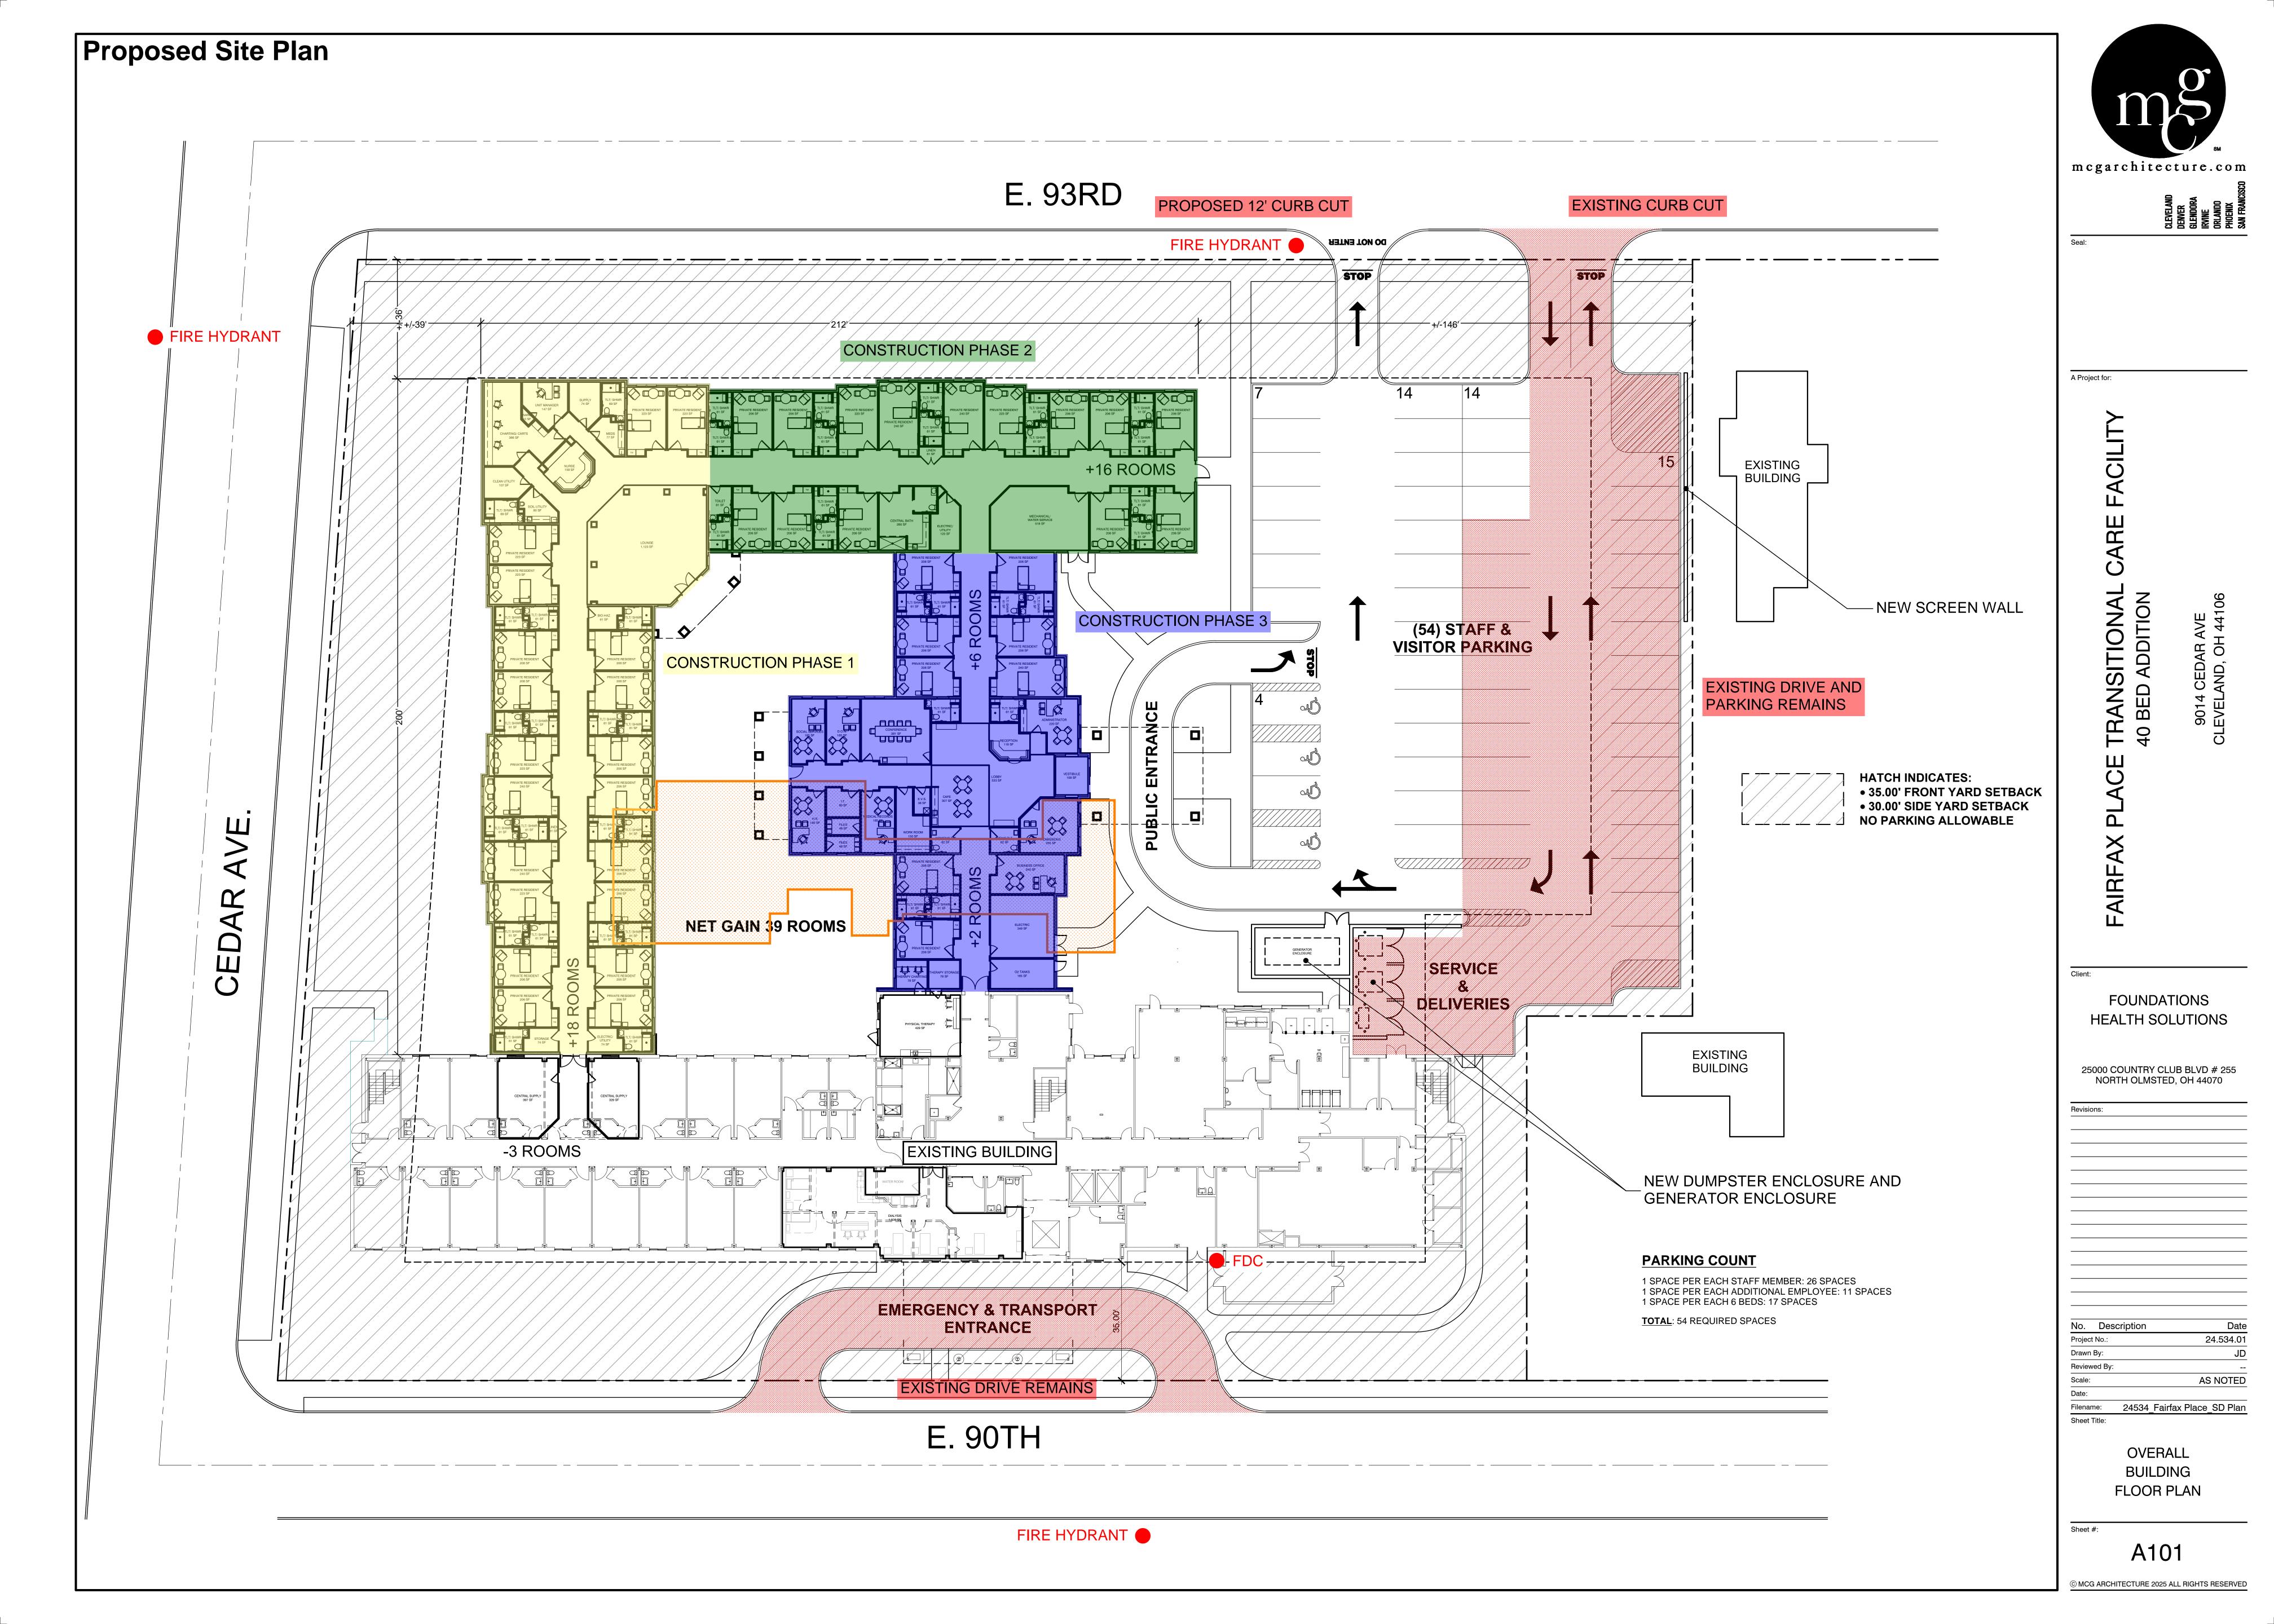1. DO NOT PRUNE SHRUBS DURING INSTALLATION 2. MEASURE ROOTBALL AND SET 1" HIGHER ON HARD PEDESTAL, DO NOT DISTURB AREA UNDERNEATH 3. SEE PLANTING NOTES FOR MULCH TYPE AND

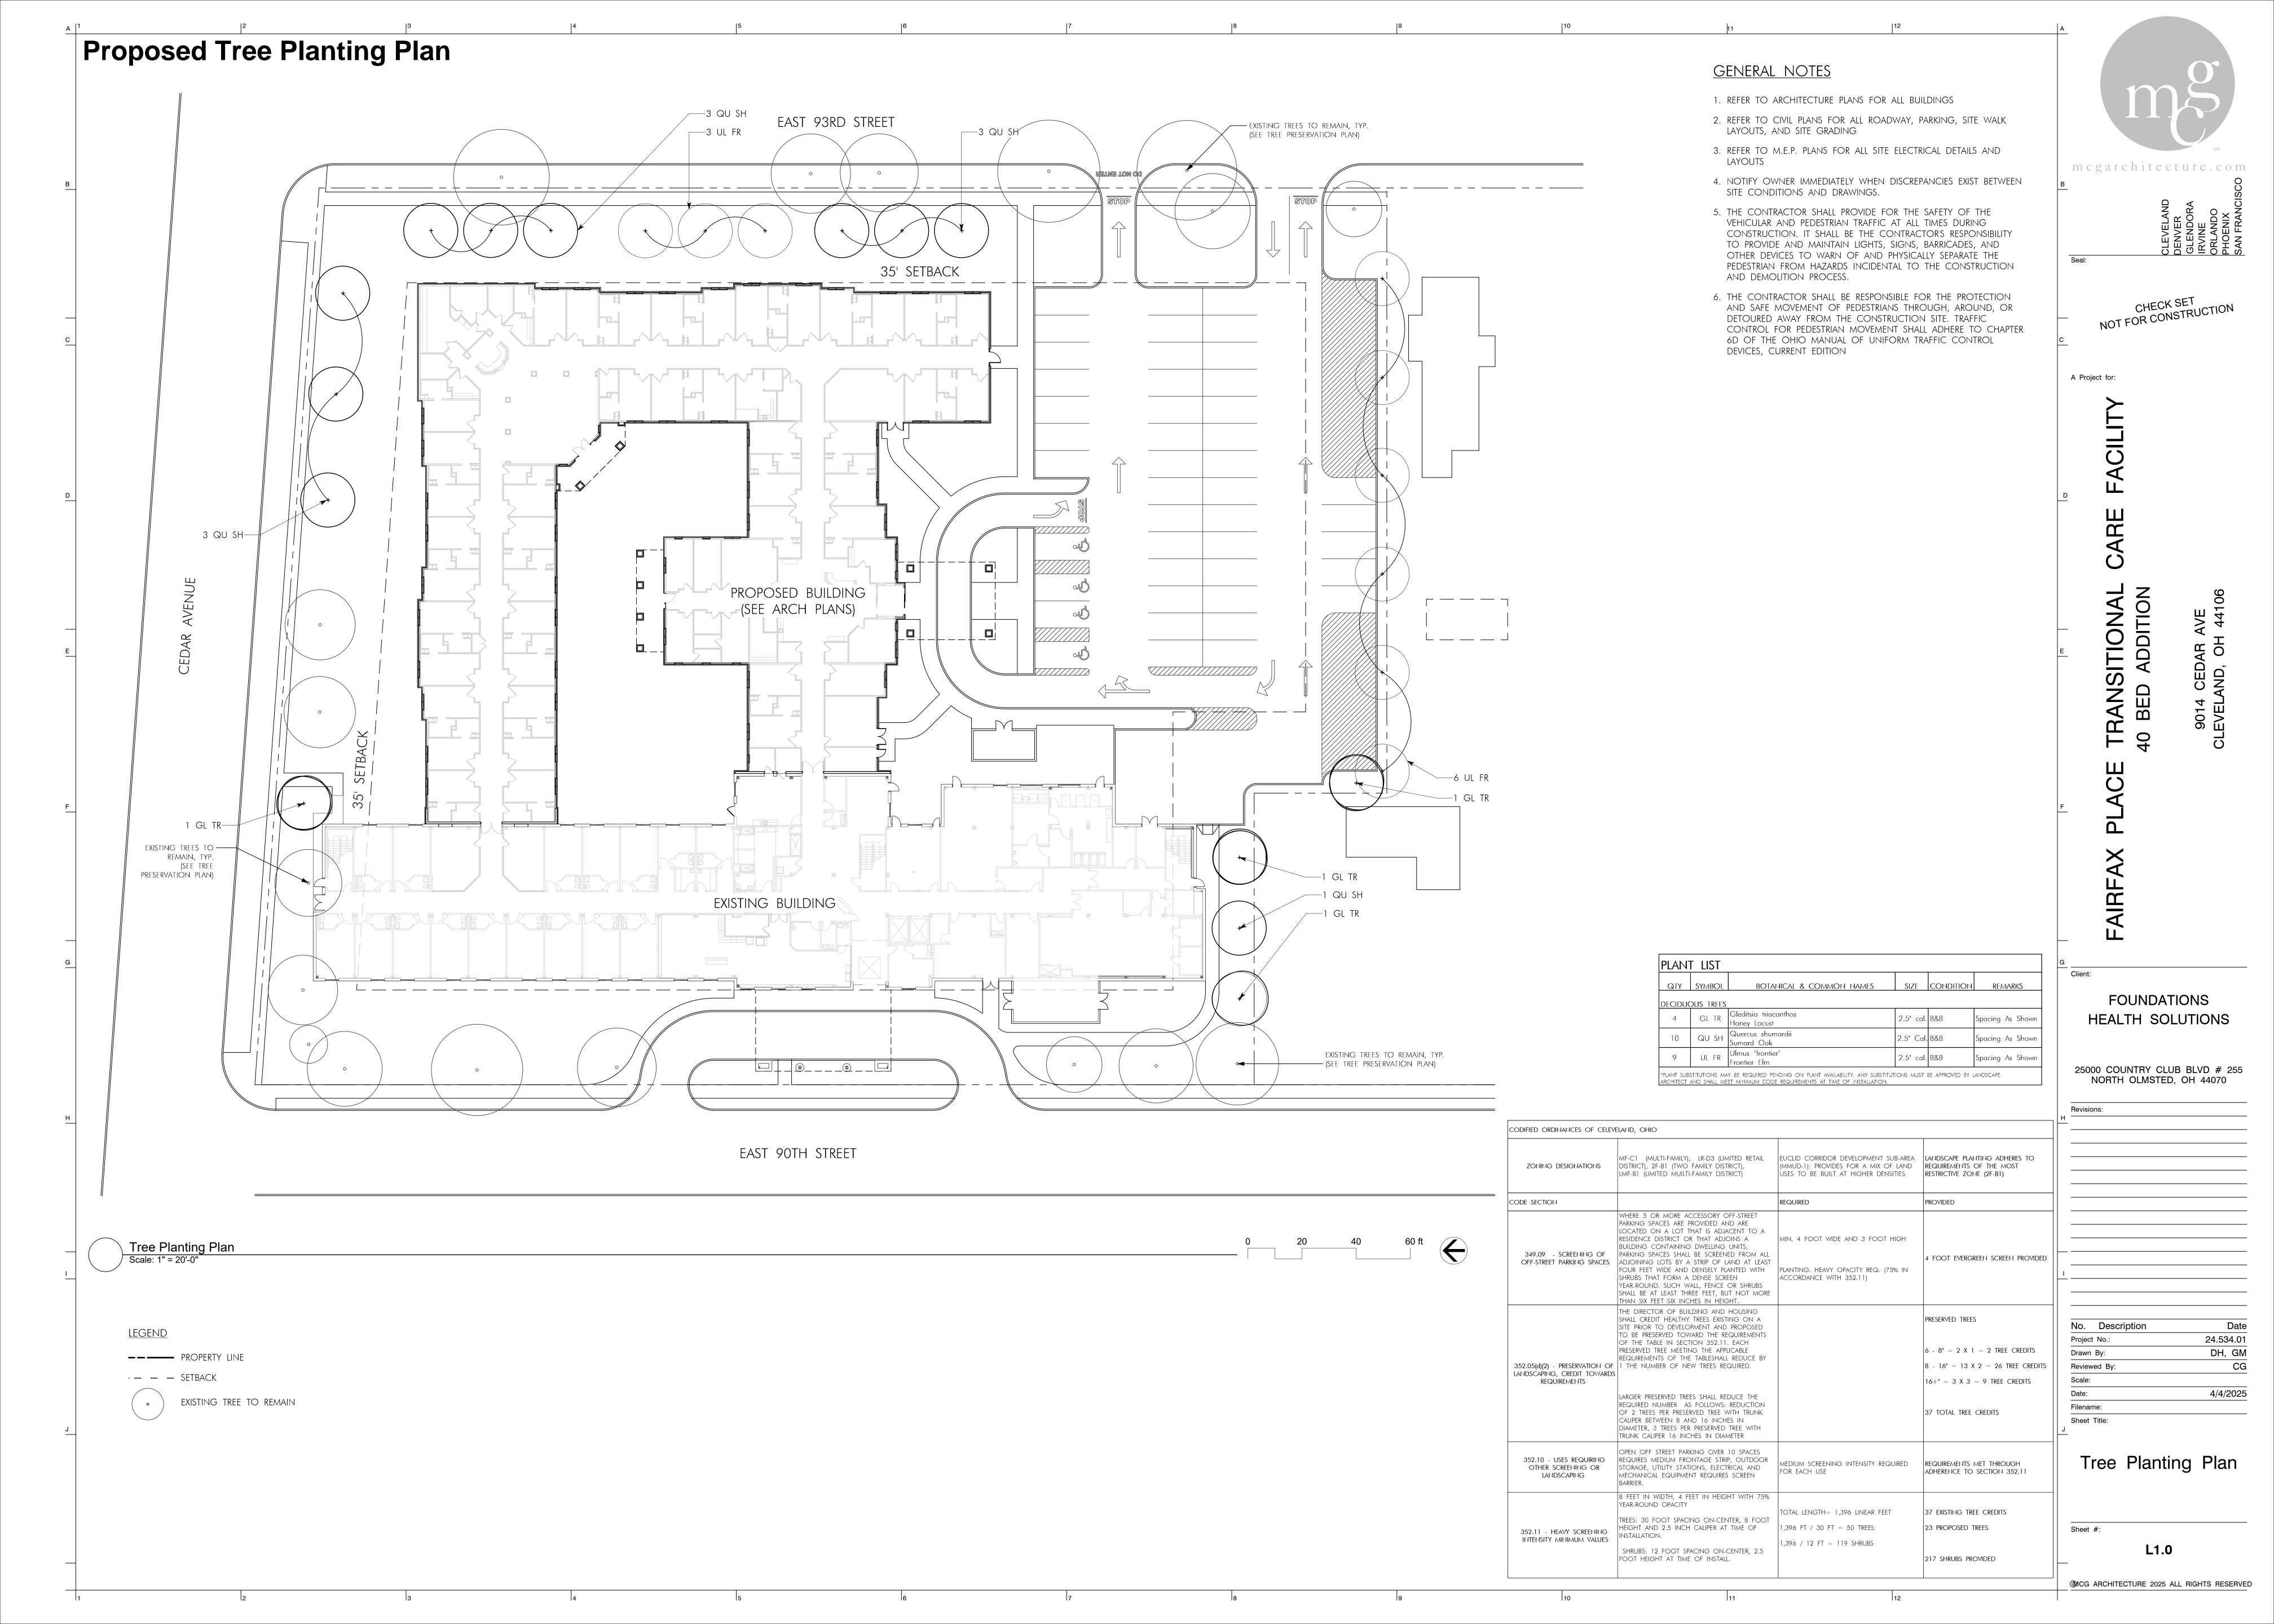
Shrub Planting
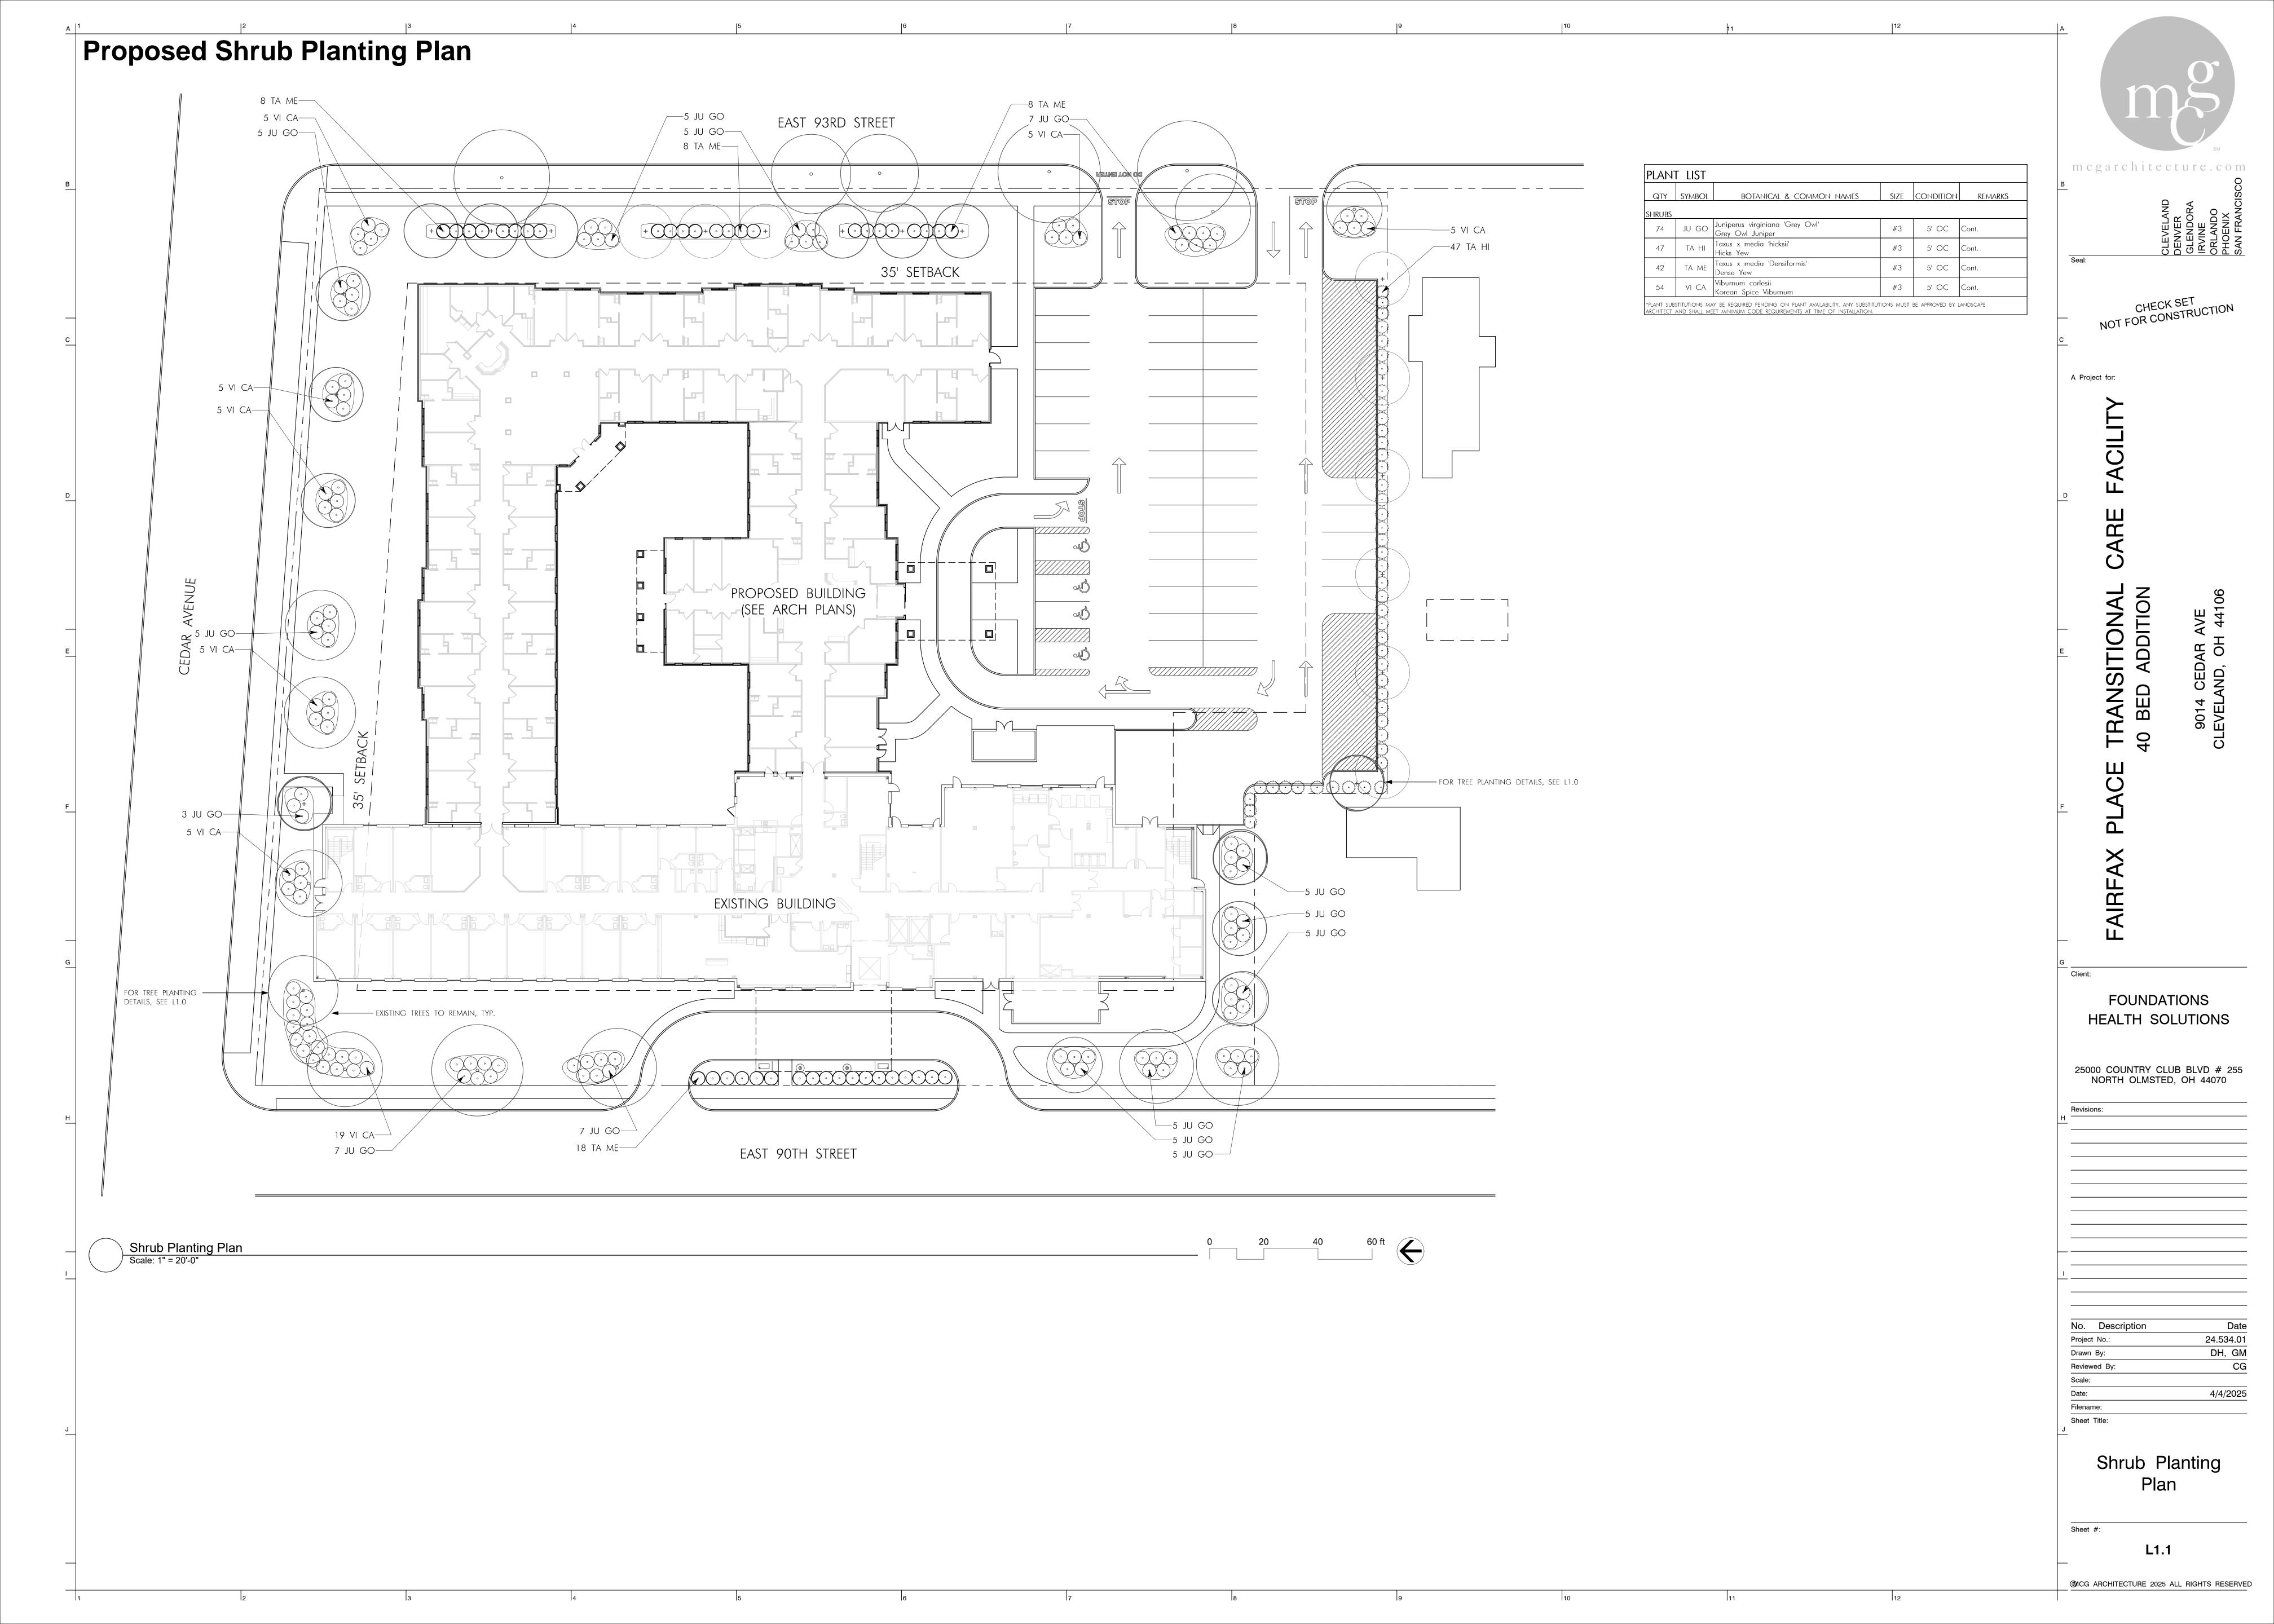
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SOIL MIXTURE AS SPECIFIED FINISHED GRADE

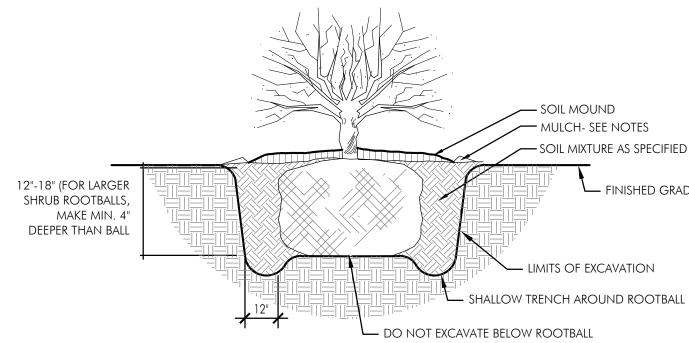
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Tree Protection

NOTE: SEE PLANTING NOTES FOR MULCH TYPE AND DEPTH

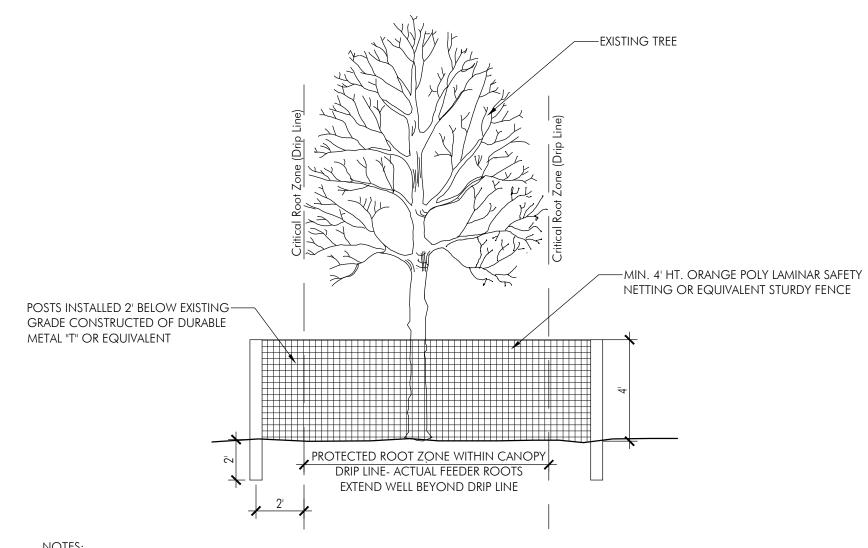

PLANT INSTALLATION NOTES

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- 2. PLANT MATERIAL SHALL BE FURNISHED IN THE QUANTITIES AND/OR SPACING AS SHOWN OR NOTED. IN CASE OF DISCREPANCIES BETWEEN THE PLAN AND THE PLANT LIST, THE PLAN SHALL DICTATE.
- 3. CONTRACTOR SHALL VERIFY SIZES AND LOCATIONS OF ALL SITE ELEMENTS AND IMMEDIATELY INFORM THE OWNER AND THE LANDSCAPE ARCHITECT OF ANY DISCREPANCY BETWEEN THE DRAWINGS AND/OR SPECIFICATIONS AND ACTUAL CONDITIONS. NO WORK SHALL BE DONE IN ANY AREA WHERE THERE IS A DISCREPANCY WITHOUT OWNER'S APPROVAL.
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- 5. CONTRACTOR SHALL PROVIDE THE FOLLOWING SOIL AMENDMENTS: SOIL AMENDMENT: 'COM-TIL' ORGANIC COMPOST (OR EQUAL): 7000 STATE ROUTE 104 SOUTH LOCKBOURNE, OHIO 43137

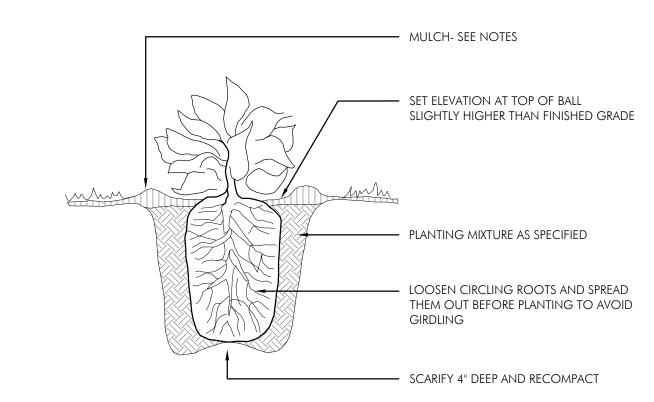(614) 645-3152

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- 11.PERFORM CLEANING DURING INSTALLATION OF LANDSCAPE WORK AND UPON COMPLETION. REMOVE from site all excess landscape related material, soil debris and equipment. Repair damage resulting from landscaping operations. Sweep and hose down paved surfaces affected by LANDSCAPING OPERATIONS. COORDINATE WITH OWNER AND OTHER CONTRACTORS FOR FINAL CLEANUP PRIOR TO CLEANING.
- 12.MAINTENANCE: THE LANDSCAPE CONTRACTOR SHALL MAINTAIN THE COMPLETED LANDSCAPE AND IRRIGATION SYSTEMS UNTIL THE DATE OF FINAL ACCEPTANCE.

A.MOWING - MINIMUM ONCE PER WEEK.

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- 16.FINISHED TURF (SOD) TO BE FLUSH WITH TOP OF ADJACENT CURB OR WALK. COORDINATE WITH Owner in field as required.
- 17.PLANT LOCATIONS AND BEDS SHALL BE LOCATED BY CONTRACTOR AND APPROVED BY OWNER AND LANDSCAPE ARCHITECT PRIOR TO PLANT INSTALLATION.

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A Project for:

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FOUNDATIONS HEALTH SOLUTIONS


25000 COUNTRY CLUB BLVD # 255 NORTH OLMSTED, OH 44070

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| No. Description | Date |
|-----------------|-----------|
| Project No.: | 24.534.01 |
| Drawn By: | DH, GM |
| Reviewed By: | CG |
| Scale: | |
| Date: | 4/4/2025 |
| Filename: | |
| | |

Planting Details

(MCG ARCHITECTURE 2025 ALL RIGHTS RESERVED

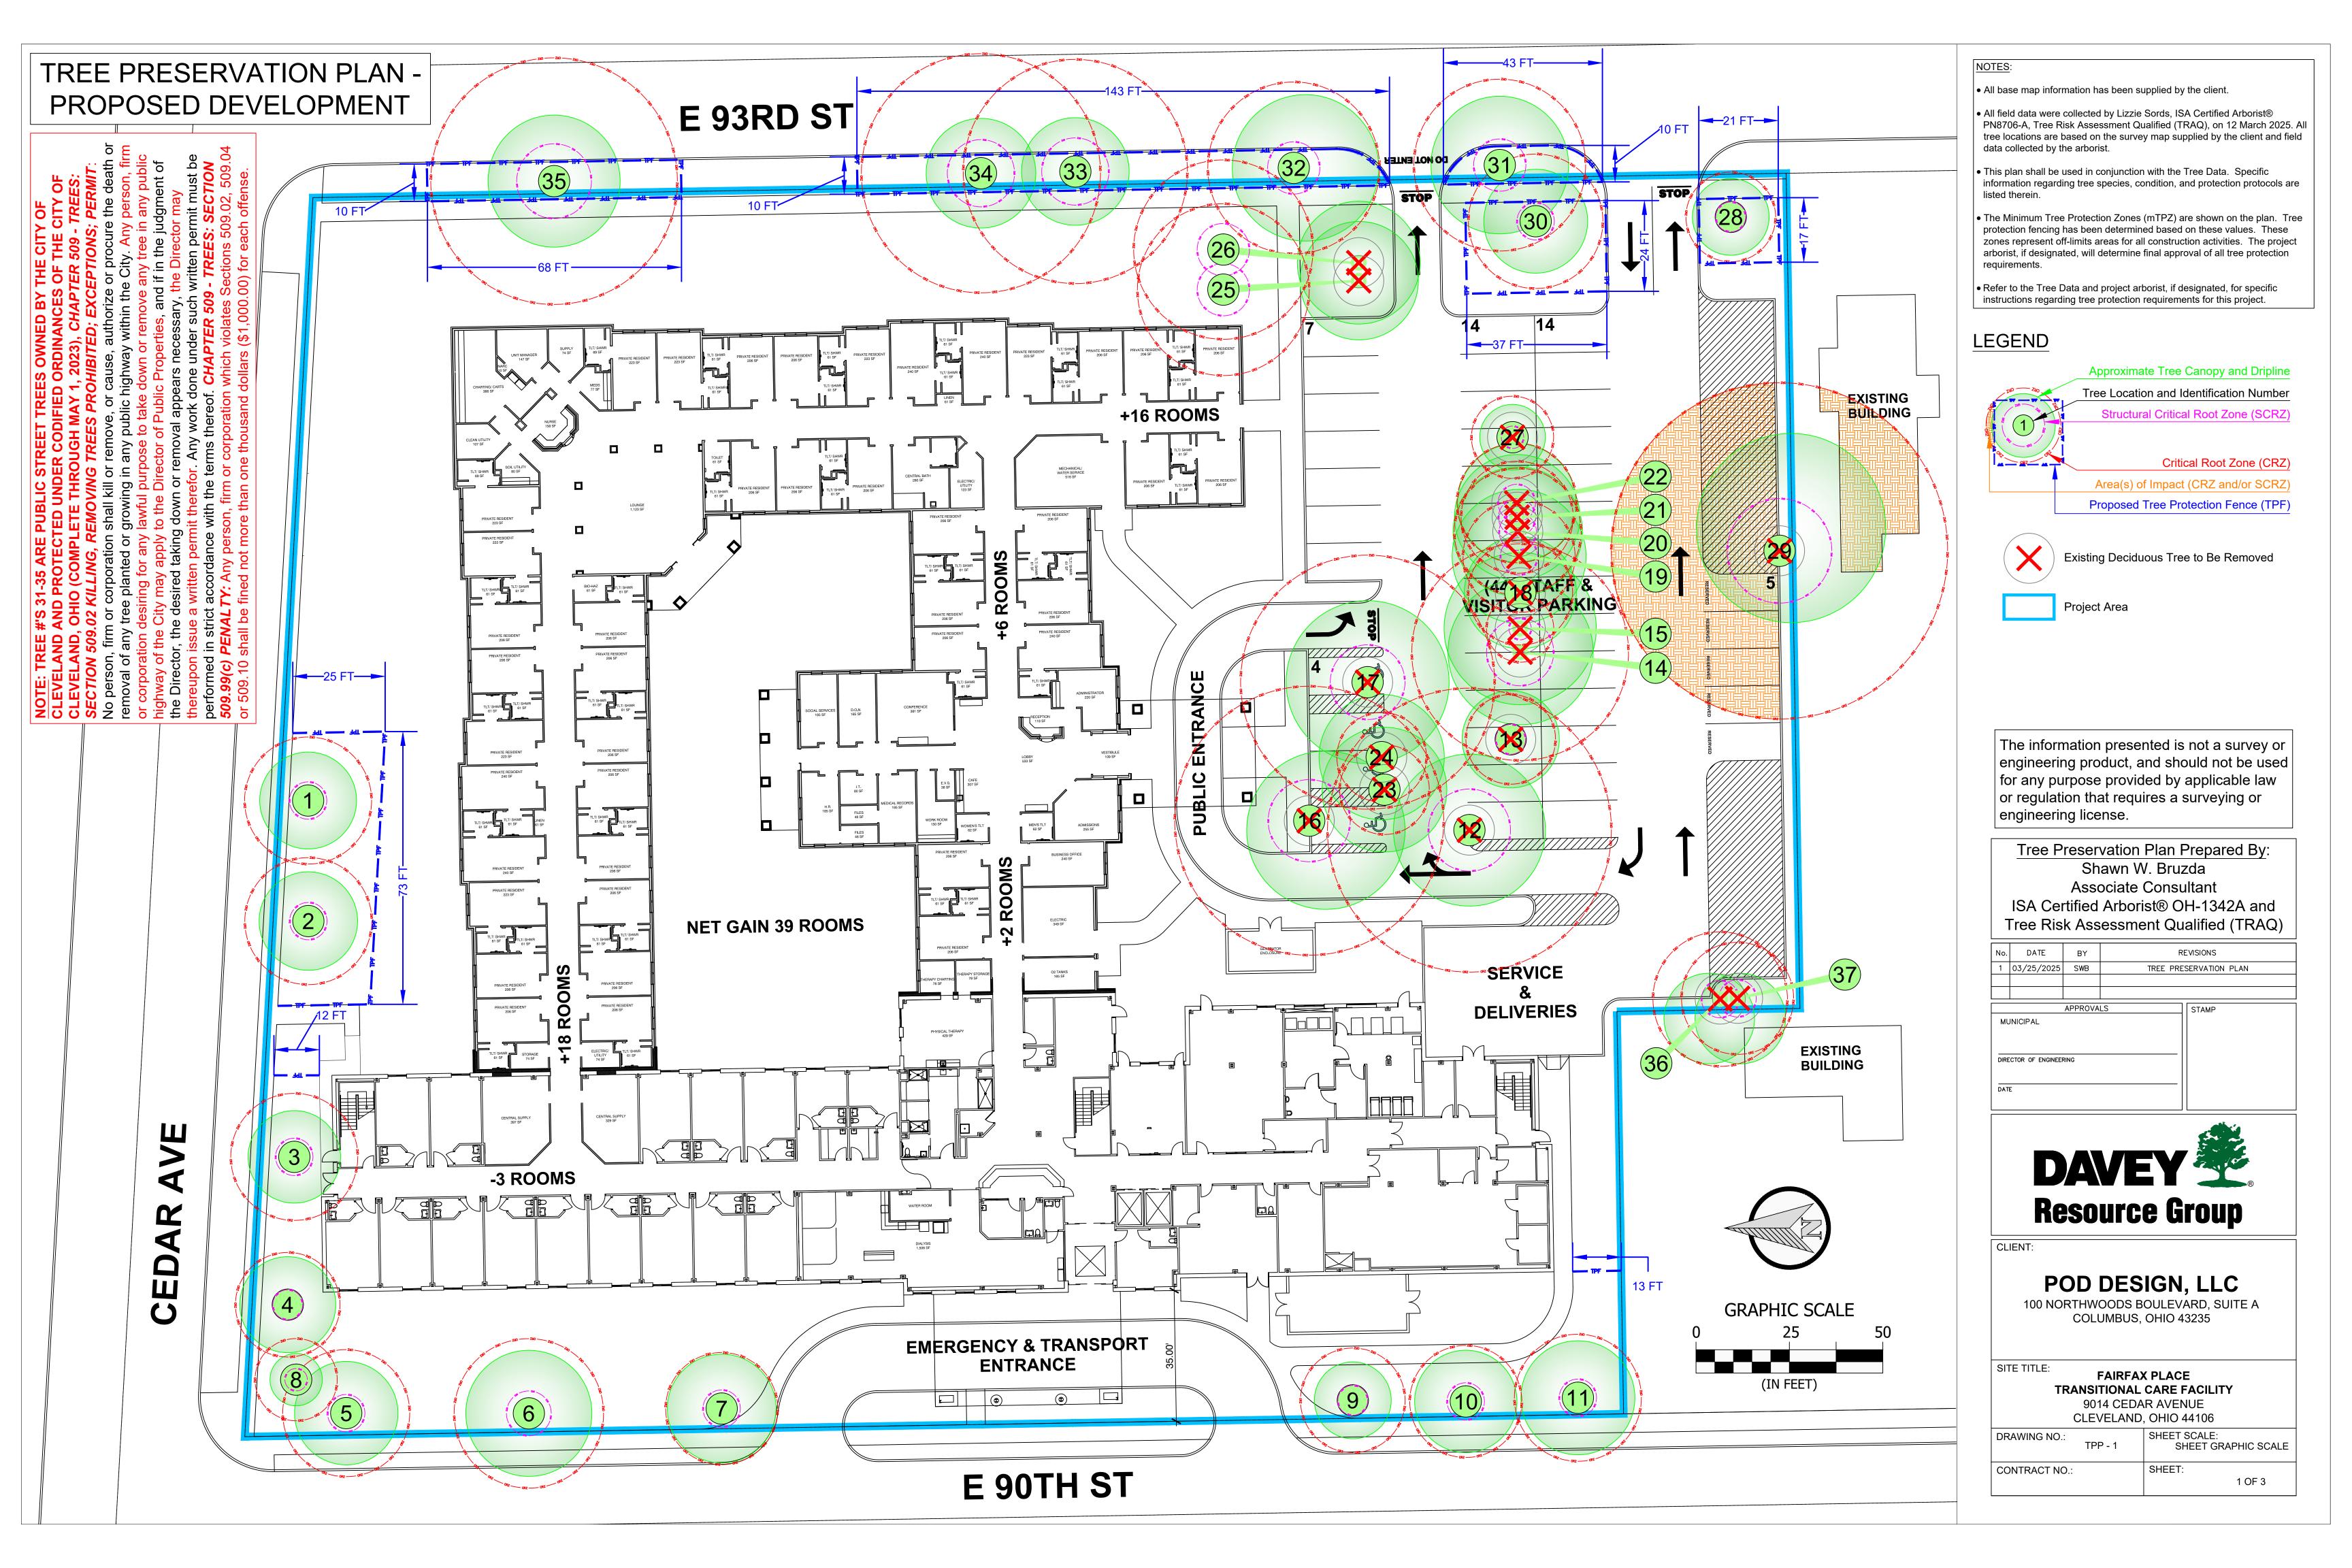

| TREE NUMBER | COMMON NAME | BOTANICAL NAME | DBH (inches) | HEIGHT (feet) | CONDITION | MAINTENANCE | STEMS | SCRZ RADIUS (feet) | CRZ RADIUS (feet) | NATIVE SPECIES? | OWNERSHIP | NOTES | DATE |
|----------------|---------------------|---------------------|-----------------|------------------|-----------|-------------|-------|-----------------------|----------------------|--------------------|----------------|--------------------|-----------|
| 1 | red maple | Acer rubrum | 11 | 25 | Fair | Prune | 1 | 5 | 17 | Yes | Private | | 12-Mar-25 |
| 2 | red maple | Acer rubrum | 11 | 25 | Fair | Prune | 1 | 5 | 17 | Yes | Private | | 12-Mar-25 |
| 3 | red maple | Acer rubrum | 11 | 25 | Fair | Prune | 1 | 5 | 17 | Yes | Private | SLF oothecae | 12-Mar-25 |
| 4 | red maple | Acer rubrum | 9 | 20 | Fair | Prune | 1 | 4 | 14 | Yes | Private | | 12-Mar-25 |
| 5 | red maple | Acer rubrum | 11 | 25 | Fair | Prune | 1 | 5 | 17 | Yes | Private | | 12-Mar-25 |
| 6 | red maple | Acer rubrum | 13 | 30 | Fair | Prune | 1 | 6 | 20 | Yes | Private | | 12-Mar-25 |
| 7 | red maple | Acer rubrum | 10 | 25 | Fair | Prune | 1 | 5 | 15 | Yes | Private | | 12-Mar-25 |
| 8 | flowering crabapple | Malus sp. | 7 | 8 | Fair | Prune | 1 | 3 | 11 | Yes | Private | | 12-Mar-25 |
| 9 | red maple | Acer rubrum | 9 | 20 | Fair | Prune | 1 | 4 | 14 | Yes | Private | | 12-Mar-25 |
| 10 | red maple | Acer rubrum | 10 | 25 | Fair | Prune | 1 | 5 | 15 | Yes | Private | | 12-Mar-25 |
| 11 | red maple | Acer rubrum | 11 | 25 | Fair | Prune | 1 | 5 | 17 | Yes | Private | | 12-Mar-25 |
| 12 | Norway maple | Acer platanoides | 25 | 50 | Poor | Remove | 1 | 11 | 38 | No | Private | severe decline | 12-Mar-25 |
| 13 | American elm | Ulmus americana | 8 | 15 | Poor | Remove | 1 | 4 | 12 | Yes | Private | | 12-Mar-25 |
| 14 | silver maple | Acer saccharinum | 19 | 35 | Fair | Remove | 1 | 9 | 29 | Yes | Private | | 12-Mar-25 |
| 15 | northern catalpa | Catalpa speciosa | 6 | 15 | Fair | Remove | 1 | 3 | 9 | Yes | Private | | 12-Mar-25 |
| 16 | Norway maple | Acer platanoides | 24 | 50 | Fair | Remove | 1 | 11 | 36 | No | Private | | 12-Mar-25 |
| 17 | Norway maple | Acer platanoides | 14,18 | 20 | Fair | Remove | 2 | 10 | 34 | No | Private | | 12-Mar-25 |
| 18 | tree of heaven | Ailanthus altissima | 9 | 15 | Fair | Remove | 1 | 4 | 14 | No | Private | | 12-Mar-25 |
| 19 | tree of heaven | Ailanthus altissima | 10 | 15 | Fair | Remove | 1 | 5 | 15 | No | Private | | 12-Mar-25 |
| 20 | American elm | Ulmus americana | 11 | 15 | Poor | Remove | 1 | 5 | 17 | Yes | Private | | 12-Mar-25 |
| 21 | American elm | Ulmus americana | 10 | 15 | Poor | Remove | 1 | 5 | 15 | Yes | Private | | 12-Mar-25 |
| 22 | Norway maple | Acer platanoides | 7,8 | 20 | Poor | Remove | 2 | 5 | 16 | No | Private | | 12-Mar-25 |
| 23 | Norway maple | Acer platanoides | 8 | 15 | Fair | Remove | 1 | 4 | 12 | No | Private | | 12-Mar-25 |
| 24 | Norway maple | Acer platanoides | 5,6 | 10 | Fair | Remove | 1 | 4 | 12 | No | Private | | 12-Mar-25 |
| 25 | tree of heaven | Ailanthus altissima | 10,12 | 15 | Fair | Remove | 2 | 7 | 23 | No | Private | | 12-Mar-25 |
| 26 | tree of heaven | Ailanthus altissima | 16 | 10 | Fair | Remove | 1 | 7 | 24 | No | Private | | 12-Mar-25 |
| 27 | tree of heaven | Ailanthus altissima | 7 | 10 | Fair | Remove | 1 | 3 | 11 | No | Private | | 12-Mar-25 |
| 28 | red maple | Acer rubrum | 8 | 20 | Fair | Prune | 1 | 4 | 12 | Yes | Private | | 12-Mar-25 |
| 29 | pin oak | Quercus palustris | 30 | 70 | Fair | Remove | 1 | 14 | 45 | Yes | Private | | 12-Mar-25 |
| 30 | red maple | Acer rubrum | 12 | 25 | Fair | Prune | 1 | 5 | 18 | Yes | Private | | 12-Mar-25 |
| 31 | sugar maple | Acer saccharum | 15 | 35 | Good | Prune | 1 | 7 | 23 | Yes | Municipal | public street tree | 12-Mar-25 |
| 32 | sugar maple | Acer saccharum | 15 | 35 | Fair | Prune | 1 | 7 | 23 | Yes | Municipal | public street tree | 12-Mar-25 |
| 33 | American basswood | Tilia americana | 20 | 40 | Fair | Prune | 1 | 9 | 30 | Yes | Municipal | public street tree | 12-Mar-25 |
| 34 | American basswood | Tilia americana | 21 | 40 | Fair | Prune | 1 | 9 | 32 | Yes | - Municipal | public street tree | 12-Mar-25 |
| 35 | American basswood | Tilia americana | 22 | 40 | Poor | Prune | 1 | 10 | 33 | Yes | Municipal | public street tree | 12-Mar-25 |
| 36 | Norway maple | Acer platanoides | 12 | 20 | Poor | Remove | 1 | 5 | 18 | No | Private | | 12-Mar-25 |
| 37 | Norway maple | Acer platanoides | 10 | 15 | Poor | Remove | 1 | 5 | 15 | No | Private | | 12-Mar-25 |

NOTES

- All base map information has been supplied by the client.
- All field data were collected by Lizzie Sords, ISA Certified Arborist®
 PN8706-A, Tree Risk Assessment Qualified (TRAQ), on 12 March 2025. All tree locations are based on the survey map supplied by the client and field data collected by the arborist.
- This plan shall be used in conjunction with the Tree Data. Specific information regarding tree species, condition, and protection protocols are listed therein.
- The Minimum Tree Protection Zones (mTPZ) are shown on the plan. Tree protection fencing has been determined based on these values. These zones represent off-limits areas for all construction activities. The project arborist, if designated, will determine final approval of all tree protection requirements.
- Refer to the Tree Data and project arborist, if designated, for specific instructions regarding tree protection requirements for this project.

TREE DATA

Tree Preservation Plan Prepared By:
Shawn W. Bruzda
Associate Consultant
ISA Certified Arborist® OH-1342A and
Tree Risk Assessment Qualified (TRAQ)

| No. | DATE | BY | REVISIONS | | | | | | | | | |
|-----|------------|----------------|------------------------|--|--|--|--|--|--|--|--|--|
| 1 | 03/25/2025 | SWB | TREE PRESERVATION PLAN | | | | | | | | | |
| | | | | | | | | | | | | |
| | | | | | | | | | | | | |
| | | <u>APPROVA</u> | LS STAMP | | | | | | | | | |
| | INICIPAL | RING | | | | | | | | | | |
| _ | | | | | | | | | | | | |
| DAT | E | | | | | | | | | | | |



CLIENT:

POD DESIGN, LLC

100 NORTHWOODS BOULEVARD, SUITE A COLUMBUS, OHIO 43235

SITE TITLE:

FAIRFAX PLACE
TRANSITIONAL CARE FACILITY
9014 CEDAR AVENUE
CLEVELAND, OHIO 44106

DRAWING NO.:

TPP - 1

SHEET SCALE:
N/A

CONTRACT NO.:

SHEET:
2 OF 3

TREE PRESERVATION SPECIFICATIONS

<u>NOTE:</u> SPECIFICATIONS 1 THROUGH 7 ARE TO BE FOLLOWED ON—SITE, AS REQUIRED. <u>SPECIFICATION 8 MUST BE FOLLOWED TO PREVENT DAMAGE TO ADJACENT STRUCTURES DURING DEMOLITION WORK.</u>

1. GENERAL

- 1.1. ALL MEASURES SHOULD BE INSPECTED AFTER INSTALLATION AND APPROVED BY CONTRACT ARBORIST, IF DESIGNATED.
- 1.2. SUBSTITUTIONS OR ALTERNATIVE METHODS OR MATERIALS SHOULD BE REVIEWED AND APPROVED BY CONTRACT ARBORIST, IF DESIGNATED.
- 1.3. ALL TREE PROTECTION MEASURES SHOULD BE IN PLACE PRIOR TO COMMENCEMENT OF DEMOLITION, SITE CLEARING, OR CONSTRUCTION AND MAINTAINED THROUGHOUT CONSTRUCTION. TREE PROTECTION MEASURES SHOULD ONLY BE REMOVED WITH CONTRACT ARBORIST APPROVAL. IF DESIGNATED.
- 1.4. REFER TO THE TREE DATA FOR SPECIFIC RECOMMENDATIONS FOR EACH TREE.

2. TREE PROTECTION FENCE

- 2.1. INSTALL PRIOR TO CLEARING & GRADING.
- 2.2. FENCE SHOULD BE MESH SNOW FENCE FABRIC MOUNTED ON 8', 1.5"Ø GALVANIZED STEEL PIPE LINE POSTS OR ALTERNATE. CORNER POSTS SHALL BE 2"Ø OR ALTERNATE (SEE DETAIL). FOR ALTERNATES, SEE SHEET 4 NOTE 2.
- 2.3. FENCE SHALL BE ATTACHED TO POSTS USING NYLON CABLE TIES.
- 2.4. TREE PROTECTION AREA SIGNS SHOULD BE ATTACHED TO ALL TREE PROTECTION FENCE AT 30' SPACING AVERAGE. SIGNS SHALL NOT BE AFFIXED DIRECTLY TO TREES (SEE DETAIL).
- 2.5. ALL SILT FENCE SHOULD BE COORDINATED FOR INSTALLÁTION TO ENHANCE PROTECTION AND AVOID UNNECESSARY ROOT CUTS BY SILT FENCE INSTALLATION.
- 2.6. TREE PROTECTION FENCE MAY BE REMOVED ONLY AFTER ALL CONSTRUCTION AND FINAL LANDSCAPING IS COMPLETE.
- 3. <u>CONSTRUCTION MONITORING/INSPECTIONS</u>
 3.1. THE CONTRACT ARBORIST, IF DESIGNATED, SHOULD MAKE REGULAR WEEKLY INSPECTIONS DURING ACTIVE CONSTRUCTION AND DEMOLITION AND PROVIDE REPORTS TO THE CLIENT. REPORTS SHOULD DOCUMENT CONDITION OF TREE PROTECTION DEVICES AND PROVIDE RECOMMENDATIONS FOR MAINTENANCE AND/OR ADDITIONAL CARE.

4. MISCELLANEOUS TREE PROTECTION REQUIREMENTS

- 4.1. NO TOXIC MATERIALS SHALL BE STORED WITHIN 100' OF TREE PROTECTION AREAS.
- 4.2. ALL WORK IN OR NEAR TREE PROTECTION AREAS SHALL BE PERFORMED IN A MANNER TO MINIMIZE DAMAGE TO TREES, SHRUBS, GROUND COVER, SOIL AND ROOT SYSTEMS.
- 4.3. MECHANIZED EQUIPMENT SHALL NOT BE PERMITTED TO ENTER ANY TREE PROTECTION AREAS (TPAS).

5. SPECIAL BY HAND DEMOLITION AND CONSTRUCTION PROCEDURES

- 5.1. DEMOLITION AND CONSTRUCTION OF IMPROVEMENTS WITHIN TREE PROTECTION AREAS SHOULD BE PERFORMED UNDER
- CONTRACT ARBORIST SUPERVISION, IF DESIGNATED.
 5.2. MECHANIZED EQUIPMENT SHALL NOT ENTER THE TPAS.
- 5.3. BACKFILL OF VOIDS FROM DEMOLITION WITHIN THE TPAS SHALL BE LOOSELY PLACED TOPSOIL. ONLY THE AMOUNT OF SOIL NECESSARY TO FILL THE VOID WITHOUT SPREADING OVER EXISTING ADJACENT GRADES SHALL BE ALLOWED.
- 5.4. ROOTS ENCOUNTERED DURING DEMOLITION OR EXCAVATION SHALL BE REVIEWED ON A CASE—BY—CASE BASIS BY CONTRACT ARBORIST, IF DESIGNATED. CONTRACT ARBORIST, IF DESIGNATED, SHALL PROVIDE APPROPRIATE TREATMENT OR PRUNING METHODS AS NEEDED AND IN GENERAL CONFORMANCE WITH ACCEPTED INDUSTRY STANDARDS AND THIS SECTION. ROOTS OVER 1"0 SHOULD NOT BE CUT WITHOUT CONTRACT ARBORIST APPROVAL, IF DESIGNATED.
- 5.5. DEMOLITION AND CONSTRUCTION OF ANY PROPOSED SIDEWALK SHOULD FOLLOW ANY LOCAL REGULATIONS FOR SIDEWALK CONSTRUCTION WITHIN TREE PROTECTION ZONES, INCLUDING NO TO MINIMAL EXCAVATION.

6. TREE CONDITION MONITORING INSPECTIONS

- 6.1. CONTRACT ARBORIST, IF DESIGNATED, SHALL PROVIDE MONITORING OF THE CONDITION OF RETAINED TREES IN TREE PROTECTION AREAS, AND TREATMENT OF DETRIMENTAL CONDITIONS (INSECTS, DISEASES, NUTRIENT DEFICIENCIES, SOIL MOISTURE, ETC.), AS THEY OCCUR, OR AS APPROPRIATE FOR EFFECTIVE MANAGEMENT.
- 6.2. INSPECTIONS SHALL BE PERFORMED AT LEAST MONTHLY DURING THE GROWING SEASON, BEGINNING PRIOR TO CONSTRUCTION AND CONTINUING THROUGHOUT CONSTRUCTION AND FOR AT LEAST ONE YEAR SUBSEQUENT TO COMPLETION OF CONSTRUCTION ACTIVITIES.
- 6.3. A WRITTEN SUMMARY REPORT INCLUDING SPECIFIC TREATMENTS MADE AND RECOMMENDATIONS FOR ADDITIONAL TREATMENTS SHALL BE PROVIDED TO THE CLIENT BY THE CONTRACT ARBORIST, IF DESIGNATED, SUBSEQUENT TO EACH

INSPECTION. 7. SSAT EXCAVATION WITHIN CRZS

- 7.1. PROPOSED DRY UTILITIES, LIGHTING CONDUITS, HARDSCAPE, OR SPRINKLERS WITHIN TREE PROTECTION AREAS (TPAS)
 SHOULD BE EXCAVATED BY SUPERSONIC AIRTOOL (SSAT) TO MINIMIZE DAMAGE TO ROOT SYSTEMS.
- 7.2. CLIENT, CONTRACTOR, CONTRACT ARBORIST, IF DESIGNATED, AND CITY SHALL REVIEW THE PROPOSED LOCATION(S)
 DURING THE PRE—CONSRUCTION MEETING.
- 7.3. PRE—WATERING OF THE PROPOSED AREAS OF EXCAVATION DURING SUMMER AND FALL MONTHS IS RECOMMENDED TO MAINTAIN ROOT / SOIL MOISTURE.
- 7.4. CONTRACT ARBORIST, IF DESIGNATED, SHALL PROVIDE A QUALIFIED ARBORIST CREW, IF DESIGNATED, EXPERIENCED WITH THE SSAT AND UTILITY EXCAVATION TO PROTECT ADJACENT TREES, OPEN THE EXCAVATION, HAND PRUNE MINOR ROOTS, AND IDENTIFY AND PROTECT PRIORITY ROOTS TO REMAIN. COORDINATION WITH THE APPROPRIATE SUB—CONTRACTOR SHALL BE MADE TO DETERMINE APPROPRIATE WIDTH, DEPTH & SEQUENCING, UTILITY INSTALLATION, BACKFILL, COMPLETION. AND COVER.

8. <u>TREE REMOVALS</u>


- 8.1. ALL TREES DESIGNATED FOR REMOVAL SHALL BE TAKEN DOWN SECTIONALLY OR DIRECTIONALLY FELLED BY A QUALIFIED CONTRACT ARBORIST, IF DESIGNATED, TO MINIMIZE DAMAGE TO ADJACENT TREE CANOPIES, ROOT SYSTEMS AND EXISTING STRUCTURES TO REMAIN. GOUGES IN TURF FROM IMPACTS SHOULD BE FILLED WITH TOPSOIL AND SEEDED AT DIRECTION OF PROJECT ARBORIST, IF DESIGNATED. DAMAGE TO ADJACENT TREES SHALL BE REVIEWED BY PROJECT ARBORIST, IF DESIGNATED. FOR REMEDIAL RECOMMENDATIONS OR REPLACEMENT.
- BESIGNATED, FOR REMEDIAL RECOMMENDATIONS OR REPLACEMENT.

 8.2. ALL WORK SHALL BE DONE BY HAND, BUCKET TRUCK OR CRANE OPERATED EQUIPMENT.
- 8.3. MOTORIZED EQUIPMENT SHALL OPERATE ON EXISTING PAVEMENT AND NOT ENTER TREE PRESERVATION AREAS WITHOUT PRIOR APPROVAL. TEMPORARY ROOT PROTECTION MATTING MAY BE REQUIRED FOR SUCH ACCESS TO PREVENT RUTTING AND COMPACTION.
- 8.4. STUMPS SHALL BE GROUND TO 6" BELOW GRADE AND GRINDINGS RAKED AND REMOVED FROM SITE; BACKFILL HOLES WITH APPROVED TOPSOIL. COORDINATE WITH UNDERGROUND UTILITIES LOCATORS PRIOR TO STUMP GRINDING.

IMPORTANT TREE PROTECTION/REMOVAL REQUIREMENTS:

APPLICABLE CODIFIED ORDINANCES OF THE CITY OF CLEVELAND, OHIO (CURRENT THROUGH LEGISLATION PASSED 3 MARCH 2025) CONCERNING THIS TREE PRESERVATION PLAN: CHAPTER 341 — DESIGN REVIEW (SECTION 341.051 TREE PRESERVATION PLAN REQUIRED); CHAPTER 509 — TREES (SECTION 509.02 KILLING, REMOVING TREES PROHIBITED; EXCEPTIONS; PERMIT and SECTION 509.14 PROTECTING TREES DURING CONSTRUCTION and SECTION 509.99 PENALTY [SEE (a-c), (d:1-3) and (e) and (g)]

- 1. ACCESSED THROUGH: https://codelibrary.amlegal.com/codes/cleveland/latest/cleveland_oh/0-0-0-1 ACCESSED ON 25 MARCH 2025
- 2. CODIFIED ORDINANCES OF THE CITY OF CLEVELAND, OHIO DISCLAIMER: This Code of Ordinances and/or any other documents that appear on this site may not reflect the most current legislation adopted by the Municipality. American Legal Publishing provides these documents for informational purposes only. These documents should not be relied upon as the definitive authority for local legislation. Additionally, the formatting and pagination of the official printed copy of a Code of Ordinances should be consulted prior to any action being taken. For further information regarding the official version of any of this Code of Ordinances or other documents posted on this site, please contact the Municipality directly or contact American Legal Publishing toll—free at 800—445—5588 (website: www.amlegal.com).
- 3. TREE #'s 31-35 ARE PUBLIC STREET TREES OWNED BY THE CITY OF CLEVELAND AND PROTECTED UNDER CODIFIED ORDINANCES OF THE CITY OF CLEVELAND, OHIO (COMPLETE THROUGH MAY 1, 2023), CHAPTER 509 TREES: SECTION 509.02 KILLING, REMOVING TREES PROHIBITED; EXCEPTIONS; PERMIT: No person, firm or corporation shall kill or remove, or cause, authorize or procure the death or removal of any tree planted or growing in any public highway within the City. Any person, firm or corporation desiring for any lawful purpose to take down or remove any tree in any public highway of the City may apply to the Director of Public Properties, and if in the judgment of the Director, the desired taking down or removal appears necessary, the Director may thereupon issue a written permit therefor. Any work done under such written permit must be performed in strict accordance with the terms thereof. CHAPTER 509 TREES: SECTION 509.99(c) PENALTY: Any person, firm or corporation which violates Sections 509.02, 509.04 or 509.10 shall be fined not more than one thousand dollars (\$1,000.00) for each offense.

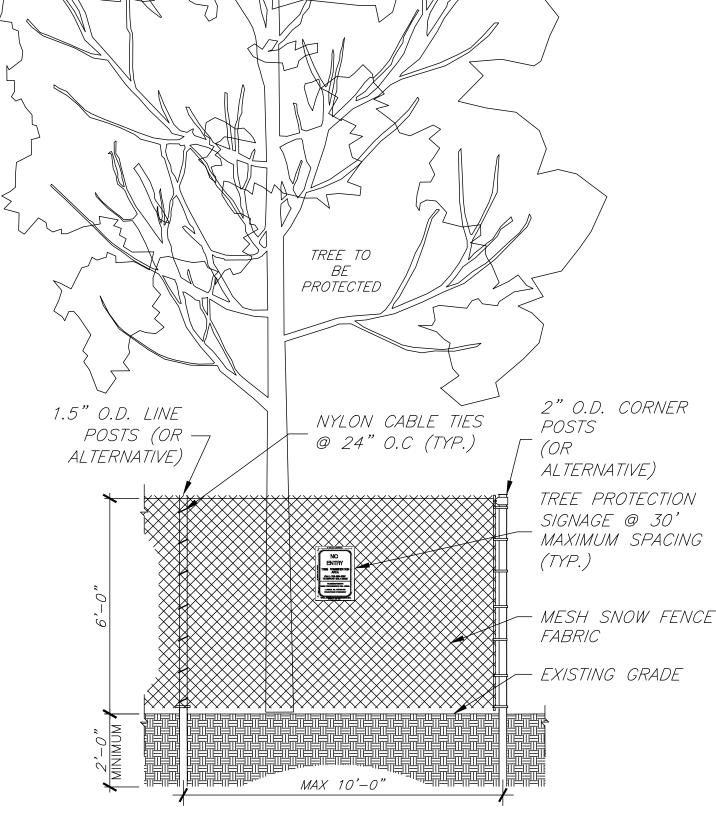

MATE

- 1. TREE PROTECTION FENCE SHALL BE INSTALLED PRIOR TO ANY SITE WORK, CLEARING OR
- 2. SUPER SILT FENCE/SNOW FENCE MAY BE USED IN LIEU OF WELDED WIRE FOR TREE PROTECTION PROVIDED IT IS INSTALLED AND MAINTAINED AS A TREE PROTECTION MEASURE AND IS POSTED WITH TREE PROTECTION SIGNS.
- 3. TREE PROTECTION FENCE SHALL BE MAINTAINED THROUGHOUT CONSTRUCTION. REMOVE FENCE ONLY WITH APPROVAL AND AFTER ALL SITE WORK HAS BEEN COMPLETED.



SUMMARY NOTE

- 1. INSTALL TREE PROTECTION FENCE AND PERFORM ROOT PRUNING PER PLAN FOR ALL PROTECTED TREES PRIOR TO ANY DEMOLITION OR CONSTRUCTION ACTIVITY.
- 2. FENCE THE PUBLIC PORTION (PARKWAYS) OF THE ENTIRE TREE PROTECTION ZONE(S) TO PREVENT WOUNDS TO THE PARKWAY TREES(S) AS WELL AS SOIL COMPACTION. POST THE FENCE WITH A SIGN STATING "TREE PROTECTION ZONE KFFP OUT"
- 3. NO TRENCHING SHOULD BE DONE WITHIN THE TREE PROTECTION ZONES (TPZ) FOR ANY CONSTRUCTION ACTIVITY UNLESS
- 4. NO GRADE CHANGES SHOULD BE DONE WITHIN THE TREE PROTECTION ZONES OF PARKWAY TREES FOR ANY CONSTRUCTION ACTIVITY.
- 5. LOCATE THE PROPOSED WATER AND SEWER LINES OUTSIDE OF THE TREE PROTECTION ZONE OR INSTALL THE UTILITIES USING TRENCH—LESS METHODS. IF AT ANY TIME TWENTY—FIVE PERCENT (25%) OF THE AREA WITHIN THE TPZ IS BEING SEPARATED FROM THE TREE BY A TRENCH, THEN THE LINE SHOULD BE EITHER RELOCATED OR INSTALLED USING TRENCH—LESS METHODS.
- 6. SHOULD IT BE NECESSARY TO EXCAVATE WITHIN THE TPZ FOR DISCONNECTION OR CAPPING OF EXISTING UTILITIES, ALL TRENCHES SHOULD BE HAND DUG. NO ROOTS LARGER THAN TWO INCHES (2") SHALL BE CUT UNLESS NO OTHER ALTERNATIVE IS FEASIBLE. ALL SMALLER ROOTS THAT REQUIRE CUTTING SHALL BE CUT WITH PRUNING SAWS. CUTS SHALL BE MADE FLUSH WITH THE TREE SIDE OF THE EXCAVATION.
- 7. REMOVAL OF ANY HARDSCAPE WITHIN THE TREE PROTECTION ZONES SHOULD BE DONE BY HAND. NO ROOTS LARGER THAN TWO INCHES (2") SHALL BE CUT UNLESS NO ALTERNATIVE IS FEASIBLE. CUTS WILL BE MADE WITH A SHARP PRUNING SAW TO AVOID TEARING AND WILL BE FLUSH WITH THE TREE SIDE OF THE TRENCH.
- 8. AT NO TIME SHALL ANY EQUIPMENT, MATERIALS, SUPPLIES OR FILL SOIL BE ALLOWED IN THE TREE PROTECTION ZONE(S).

 DO NOT STORE EXCAVATED SOIL, BUILDING MATERIALS OR A DUMPSTER WITHIN THE DRIP—LINE (TPZ) OF THE PARKWAY

 TREE(S)
- 9. THE TREE PROTECTION ZONES MAY BE MULCHED TO IMPROVE THE GROWING CONDITIONS FOR TREE ROOTS, AND MINIMIZE THE MAINTENANCE OF THE PARKWAY LAWN.
- 10. ALL WORK SHOULD BE PERFORMED ACCORDING TO THE TREE PRESERVATION PLAN. 11. THE APPROVED TREE PRESERVATION PLAN MUST BE AVAILABLE AT THE CONSTRUCTION SITE.
- 12. ALL REQUIRED TREE PROTECTION FENCING SHALL REMAIN IN PLACE UNTIL THE TIME OF FINAL GRADING AND LANDSCAPING.
 **TREE PROTECTION ZONE (TPZ) IS THE DESIGNATED AREA THAT ENCOMPASSES AN ENTIRE TREE CANOPY.

ADDITIONAL NOTES:

- 1. TREE LOCATIONS MAY BE APPROXIMATE. CLIENT AND CONTRACT ARBORIST SHOULD VERIFY ALL TREE LOCATIONS AND CONDITIONS PRIOR TO CONSTRUCTION AND/OR TREATMENT OR REMOVAL.
- 2. A PRE-CONSTRUCTION MEETING SHOULD BE HELD PRIOR TO COMMENCEMENT OF DEMOLITION/CONSTRUCTION ACTIVITY. CITY, CLIENT, DESIGN TEAM MEMBERS (PROJECT ARBORIST, LANDSCAPE ARCHITECT, ENGINEER, ARCHITECT, ETC.), CONTRACT ARBORIST, SITE AND LANDSCAPE CONTRACTORS SHOULD ATTEND.
- 3. THE INSPECTION OF THESE TREES CONSISTED SOLELY OF A VISUAL INSPECTION FROM THE GROUND. WHILE MORE THOROUGH TECHNIQUES ARE AVAILABLE FOR INSPECTION AND EVALUATION, THEY WERE NEITHER REQUESTED NOR CONSIDERED NECESSARY OR APPROPRIATE AT THIS TIME.
- 4. TREES RATED "POOR" OR "DEAD" THAT ARE NOT RECOMMENDED FOR REMOVAL DUE TO CONSTRUCTION IMPACT MAY WARRANT FURTHER EVALUATION AND/OR TREATMENT OR REMOVAL.

NOT

- All base map information has been supplied by the client.
- All field data were collected by Lizzie Sords, ISA Certified Arborist®
 PN8706-A, Tree Risk Assessment Qualified (TRAQ), on 12 March 2025. All
 tree locations are based on the survey map supplied by the client and field
 data collected by the arborist.
- This plan shall be used in conjunction with the Tree Data. Specific information regarding tree species, condition, and protection protocols are listed therein.
- The Minimum Tree Protection Zones (mTPZ) are shown on the plan. Tree
 protection fencing has been determined based on these values. These
 zones represent off-limits areas for all construction activities. The project
 arborist, if designated, will determine final approval of all tree protection
 requirements.
- Refer to the Tree Data and project arborist, if designated, for specific instructions regarding tree protection requirements for this project.

Tree Preservation Plan Prepared By:
Shawn W. Bruzda
Associate Consultant
ISA Certified Arborist® OH-1342A and
Tree Risk Assessment Qualified (TRAQ)

| No. | DATE | BY | REVISIONS | | | | | | | |
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CLIENT:

POD DESIGN, LLC

100 NORTHWOODS BOULEVARD, SUITE A

COLUMBUS, OHIO 43235

SITE TITLE:

FAIRFAX PLACE TRANSITIONAL CARE FACILITY 9014 CEDAR AVENUE

CLEVELAND, OHIO 44106

DRAWING NO.:
TPP - 1

SHEET SCALE:
N/A

CONTRACT NO.:
SHEET:
3 OF 3

Project Schedule

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